

### PLAN REFERENCES:

- RIVERLAND SUBDIVISION, LAND SUBDIVISION OF DONALD & LOIS BOOTH, CANTERBURY, NH, SCALE: 1"=100', DATED FEBRUARY 1992, PLAN BY ROSTRON SITE SERVICES. RECORDED IN THE MERRIMACK COUNTY REGISTRY OF DEEDS AS PLAN #12402.
- 2. DONALD & LOIS BOOTH SUBDIVISION, LAND OF DONALD & LOIS BOOTH, RIVERLAND ROAD, CANTERBURY, NH 03224, SCALE: 1"=50', DATED AUGUST 7, 1999, REVISED 10-23-2000, PREPARED BY RAYMOND G. CUSHMAN, LLS #281, DRAWN BY ROBERT T. FRENCH AND RECORDED IN THE MERRIMACK COUNTY REGISTRY OF DEEDS AS PLAN #15332.
- SUBDIVISION PLAN, DON AND LOIS BOOTH, CANTERBURY, NH, DATED 5-11-89, SCALE: 1"=100', SHEET NO 1 OF 2 AND 2 OF 2, PREPARED BY HOLDEN ENGINEERING & SURVEYING, INC. OF CONCORD, NH AND RECORDED IN THE MERRIMACK COUNTY REGISTRY OF DEEDS AS PLAN #11151.

### NOTES:

- 1. THE PURPOSE OF THIS PLAN IS TO SHOW THE EXISTING CONDITIONS ON LOT 44 AND A PORTION OF LOT 45 ON THE TOWN OF CANTERBURY ASSESSOR'S MAP 267.
- 2. THE PROPERTY IS LOCATED IN THE "C" COMMERCIAL DISTRICT AS SHOWN ON THE CANTERBURY ZONING MAP. THE PROPERTY IS SUBJECT TO THE FOLLOWING DIMENSIONAL RESTRICTIONS:

STRICTIONS:

MINIMUM FRONTAGE:

MINIMUM LOT SIZE:

MINIMUM LOT DEPTH:

MINIMUM LOT WIDTH:

BUILDING SETBACKS:

FRONT

50 FEET

- 3. THE TOPOGRAPHIC INFORMATION SHOWN HEREON IS THE RESULT OF A FIELD SURVEY PERFORMED BY THIS OFFICE IN OCTOBER 2021 WITH UPDATES IN MAY 2023. THE VERTICAL DATUM IS NGVD29 BASED ON GPS OBSERVATIONS PERFORMED BY THIS
- 4. THE BOUNDARY LINES ARE FROM PLAN REFERENCE #1, WHICH HAS BEEN ROTATED INTO NH STATE PLANE, NAD 83/96 BASED ON GPS OBSERVATIONS PERFORMED BY THIS OFFICE IN 2007.
- 5. THE SUBJECT PARCEL DOES NOT LIE WITHIN THE 100-YEAR FLOOD HAZARD AREA AS DEFINED ON THE FLOOD INSURANCE RATE MAP FOR THE TOWN OF CANTERBURY, COMMUNITY NUMBER 330108, PANEL 0337 E DATED APRIL 19, 2010.

COMMUNITY NUMBER 330108, PANEL 0337 E DATED APRIL 19, 6. SITE WAS INSPECTED FOR WETLANDS AND NONE WERE FOUND.

EXISTING CONDITIONS PLAN

PREPARED FOR

## McKERLEY PROPERTIES, LLC


ASSESSORS MAP 267 LOT 44 & 45

RIVERLAND ROAD & 2 OXBOW POND ROAD CANTERBURY, NEW HAMPSHIRE

SCALE: 1"=30' \* DATE: AUGUST 2023

SHEET 1 OF 6

DigSafe

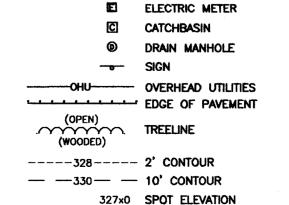


GRANITE BOUND FOUND

UTILITY POLE W/ANCHOR

EXISTING DECIDUOUS TREE

IRON ROD FOUND

SOILS
FROM THE NRCS WEB SOIL SURVEY
35A- CHAMPLAIN LOAMY FINE SAND, 0-3% SLOPES.
SOMEWHAT EXCESSIVELY DRAINED, HSG A

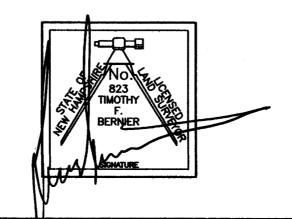

# MAP 267 LOT 45 McKERLEY PROPERTIES, LLC 459 DANIEL WEBSTER HIGHWAY BOSCAWEN, NH 03303

BOOK 3500 PAGE 2760

MAP 267 LOT 44
WARDELL HOLDINGS, LLC
730 KEARSARGE MOUNTAIN ROAD
WARNER, NH 03278
BOOK 3791 PAGE 2218

CALE		
30	60	

# T. F. BERNIER, INC. Land Surveyors - Designers - Consultants 50 DIFASANT STREET - D.O. DOY 746


50 PLEASANT STREET - P.O. BOX 3464 CONCORD, NEW HAMPSHIRE 03302-3464 Tel:(603)224-4148 - Fax:(603)224-0507

 DRAWN BY
 CHECKED BY
 F.B.
 PG.
 JOB #

 TJH
 TFB
 241
 20

 DRAWING NAME 2023\_01ExistCond
 200
 241
 20

REVISION DATE DESIGNED BY DRAW

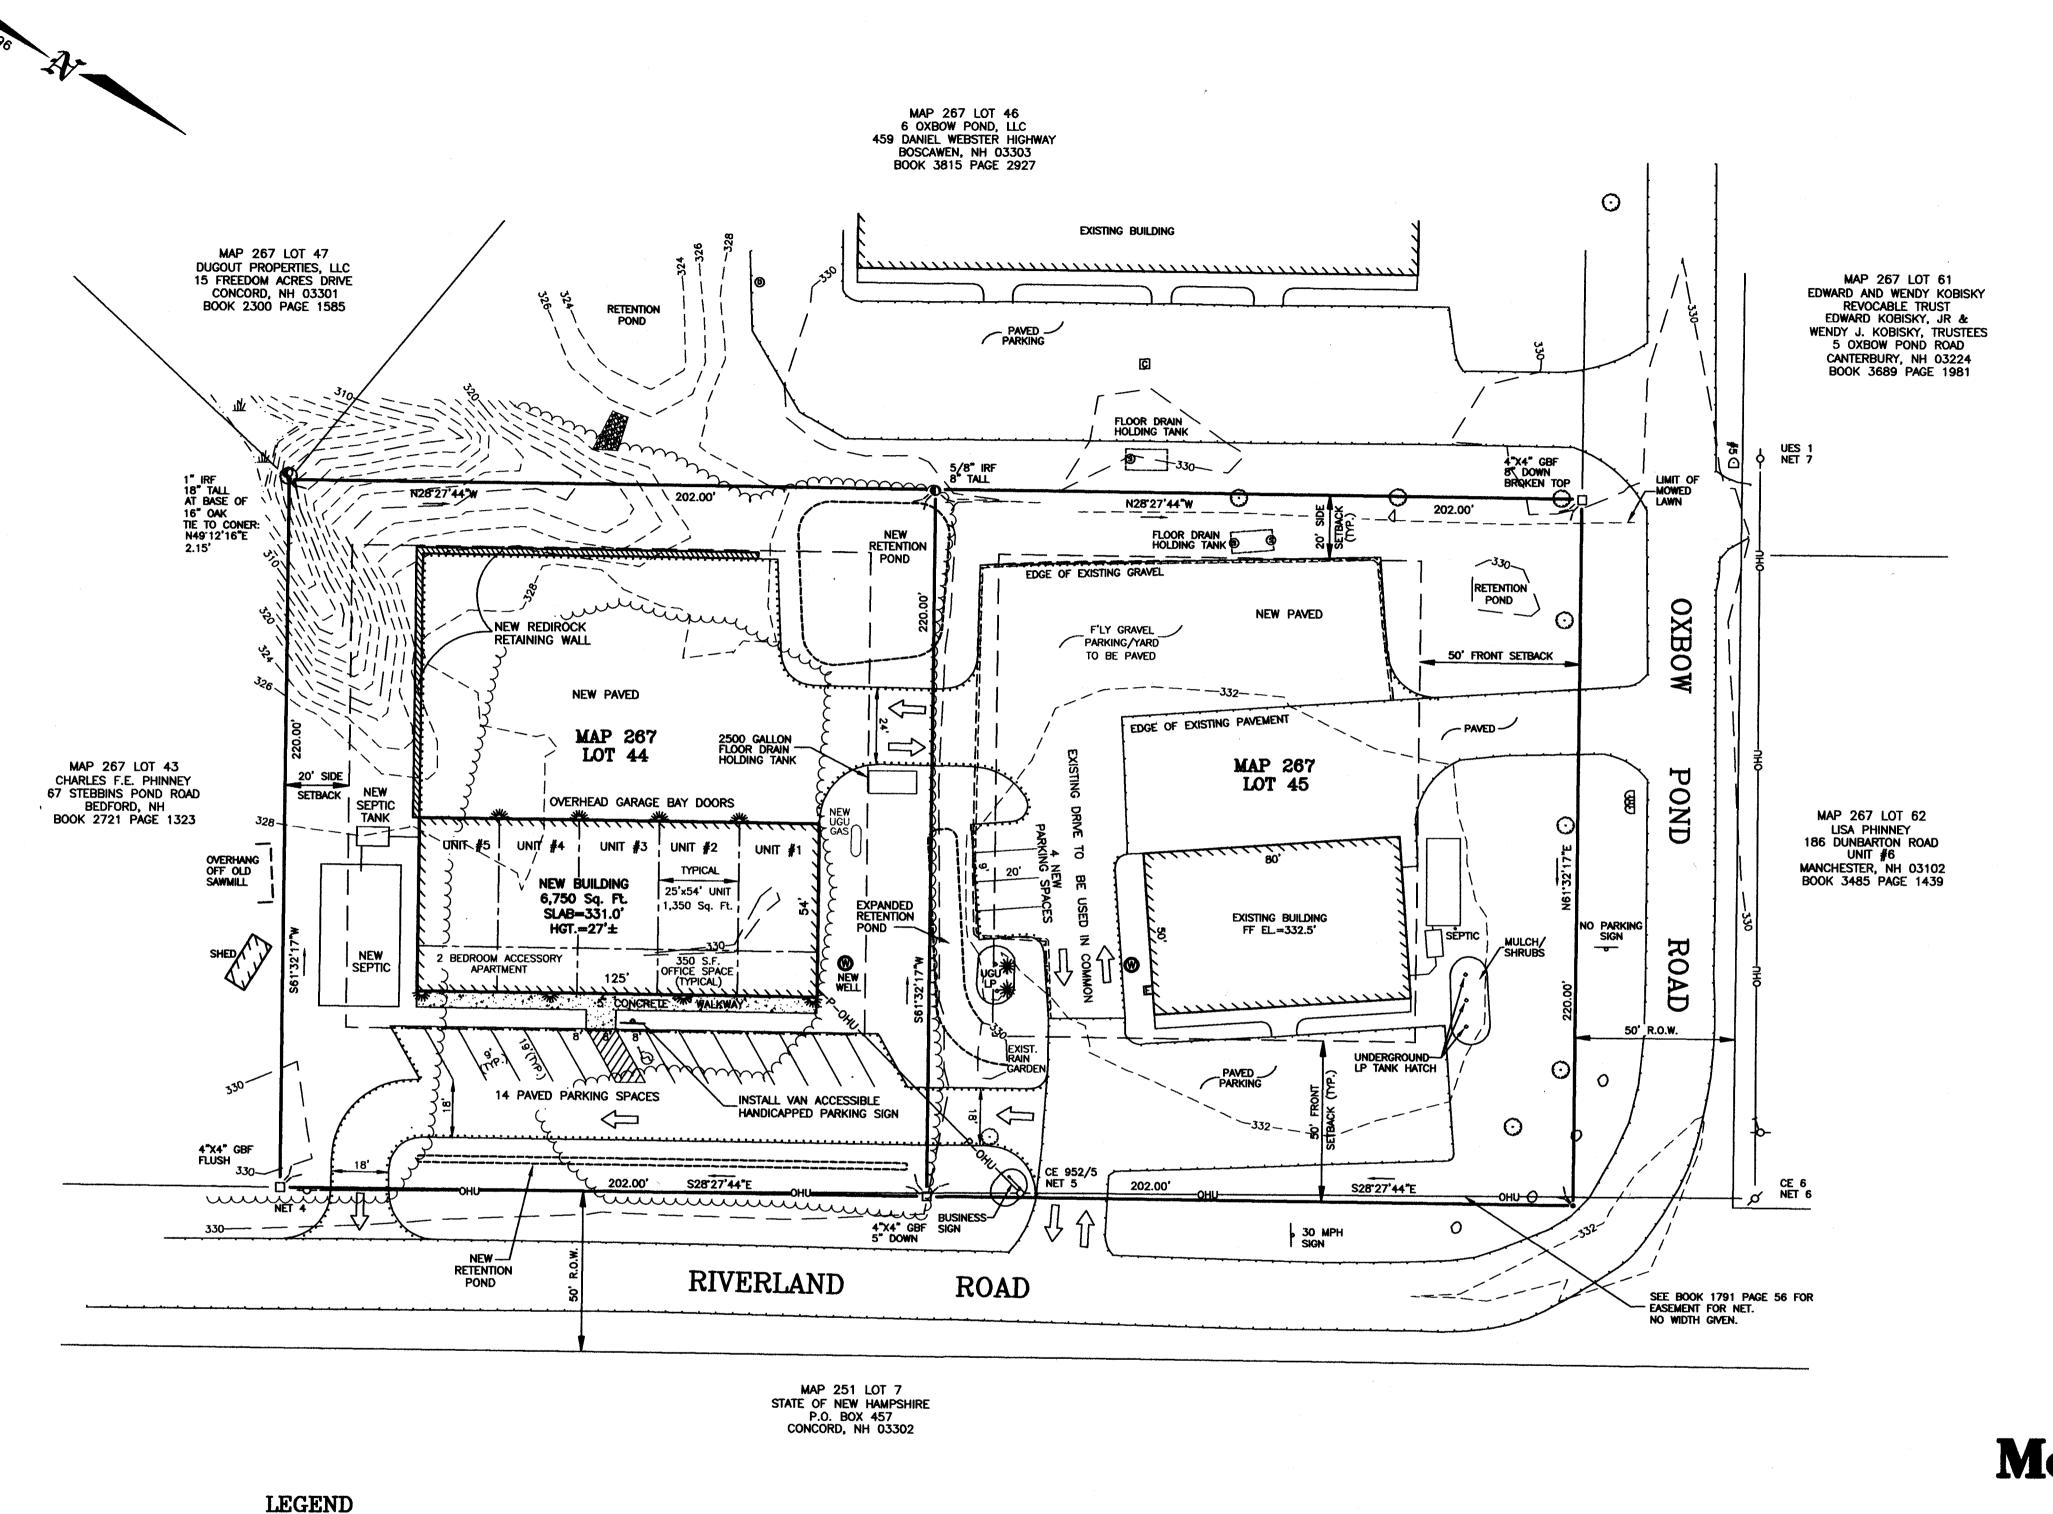

### NOTES:

- 1. THE PURPOSE OF THIS PLAN IS TO SHOW THE PROPOSED IMPROVEMENTS ON LOT 44 WITH THE CORRESPONDING REDEVELOPMENT (PAVING) ON A PORTION OF LOT 45.
- 2. THE PROPERTY IS LOCATED IN THE "C" COMMERCIAL DISTRICT AS SHOWN ON THE CANTERBURY ZONING MAP. THE PROPERTY IS SUBJECT TO THE FOLLOWING DIMENSIONAL **RESTRICTIONS:**

MINIMUM FRONTAGE: 200 FEET MINIMUM LOT SIZE: 1 ACRE MINIMUM LOT DEPTH: 150 FEET

MINIMUM LOT WIDTH: 200 FEET **BUILDING SETBACKS:** 

- SIDE & REAR: 3. THE TOPOGRAPHIC INFORMATION SHOWN HEREON IS THE RESULT OF A FIELD SURVEY PERFORMED BY THIS OFFICE IN OCTOBER 2021 WITH UPDATES IN MAY 2023. THE VERTICAL DATUM IS NGVD29 BASED ON GPS OBSERVATIONS PERFORMED BY THIS
- OFFICE IN DECEMBER 2007 4. THE BOUNDARY LINES ARE FROM PLAN REFERENCE #1, WHICH HAS BEEN ROTATED INTO NH STATE PLANE, NAD 83/96 BASED ON GPS OBSERVATIONS PERFORMED BY THIS OFFICE
- 5. THE SUBJECT PARCEL DOES NOT LIE WITHIN THE 100-YEAR FLOOD HAZARD AREA AS DEFINED ON THE FLOOD INSURANCE RATE MAP FOR THE TOWN OF CANTERBURY,
- COMMUNITY NUMBER 330108, PANEL 0337 E DATED APRIL 19, 2010. 6. SITE WAS INSPECTED FOR WETLANDS AND NONE WERE FOUND.
- 7. ON AUGUST 16, 2023 THE CANTERBURY ZONING BOARD OF ADJUSTMENT GRANTED SPECIAL EXCEPTIONS TO ALLOW AN OFFICE ESTABLISHMENT WITH OVER 5,000 SQUARE FEET OF FLOOR AREA AND AN ATTACHED DWELLING UNIT TO A BUSINESS ABOVE THE OFFICE SPACE INSIDE THE PROPOSED BUILDING ON LOT 44. CASE NO. 2023—6.

### LOT COVERAGE

LOT 45 EXISTING

AFTER SITEPLAN

4,000 S.F

CONC. & PAVE: 10,913 S.F. 21,520 S.F. TOTAL: 14,913 S.F. (33.6%)

TOTAL: 25,520 S.F. (57.4%) (WAIVER REQUESTED)

LOT 44 **PROPOSED** 

BUILDING: 6,750 S.F CONC. & PAVE: 17,758 S.F. TOTAL: 24,508 S.F. (55.1%) (WAIVER REQUESTED)

BUILDING: 4,000 S.F.

SITE PLAN

PREPARED FOR

# McKERLEY PROPERTIES, LLC


ASSESSORS MAP 267 LOT 44 & 45

RIVERLAND ROAD & 2 OXBOW POND ROAD CANTERBURY, NEW HAMPSHIRE

SCALE: 1"=30' \* DATE: AUGUST 2023

SHEET 2 OF 6



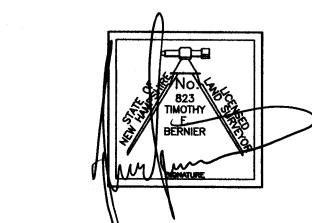

GRANITE BOUND FOUND

UTILITY POLE W/ANCHOR

TRAFFIC FLOW DIRECTION

PROPOSED OVERHEAD UTILITIES

HANDICAPPED PARKING

BUILDING MOUNTED DOWN-FACING LIGHT

EXISTING TREELINE

-OHU-----OVERHEAD UTILITIES

---328--- EXISTING 2' CONTOUR

-- -- 330 -- EXISTING 10' CONTOUR

PROPOSED EDGE OF PAVEMENT


IRON ROD FOUND

ELECTRIC METER

# APPROVED BY THE TOWN OF CANTERBURY PLANNING BOARD

#### OWNERS OF RECORD MAP 267 LOT 45 McKERLEY PROPERTIES, LLC **459 DANIEL WEBSTER HIGHWAY** BOSCAWEN, NH 03303 BOOK 3500 PAGE 2760 MAP 267 LOT 44 WARDELL HOLDINGS, LLC

730 KEARSARGE MOUNTAIN ROAD WARNER, NH 03278 BOOK 3791 PAGE 2218

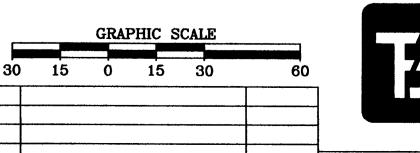


REVISION

### T. F. BERNIER, INC. Land Surveyors - Designers - Consultants

50 PLEASANT STREET - P.O. BOX 3464 CONCORD, NEW HAMPSHIRE 03302-3464 Tel:(603)224-4148 - Fax:(603)224-0507

DRAWN BY CHECKED BY F.B. PG. JOB # 564-02 TJH,JRC,TFB TFB 241 20 DRAWING NAME 2023\_Siteplan

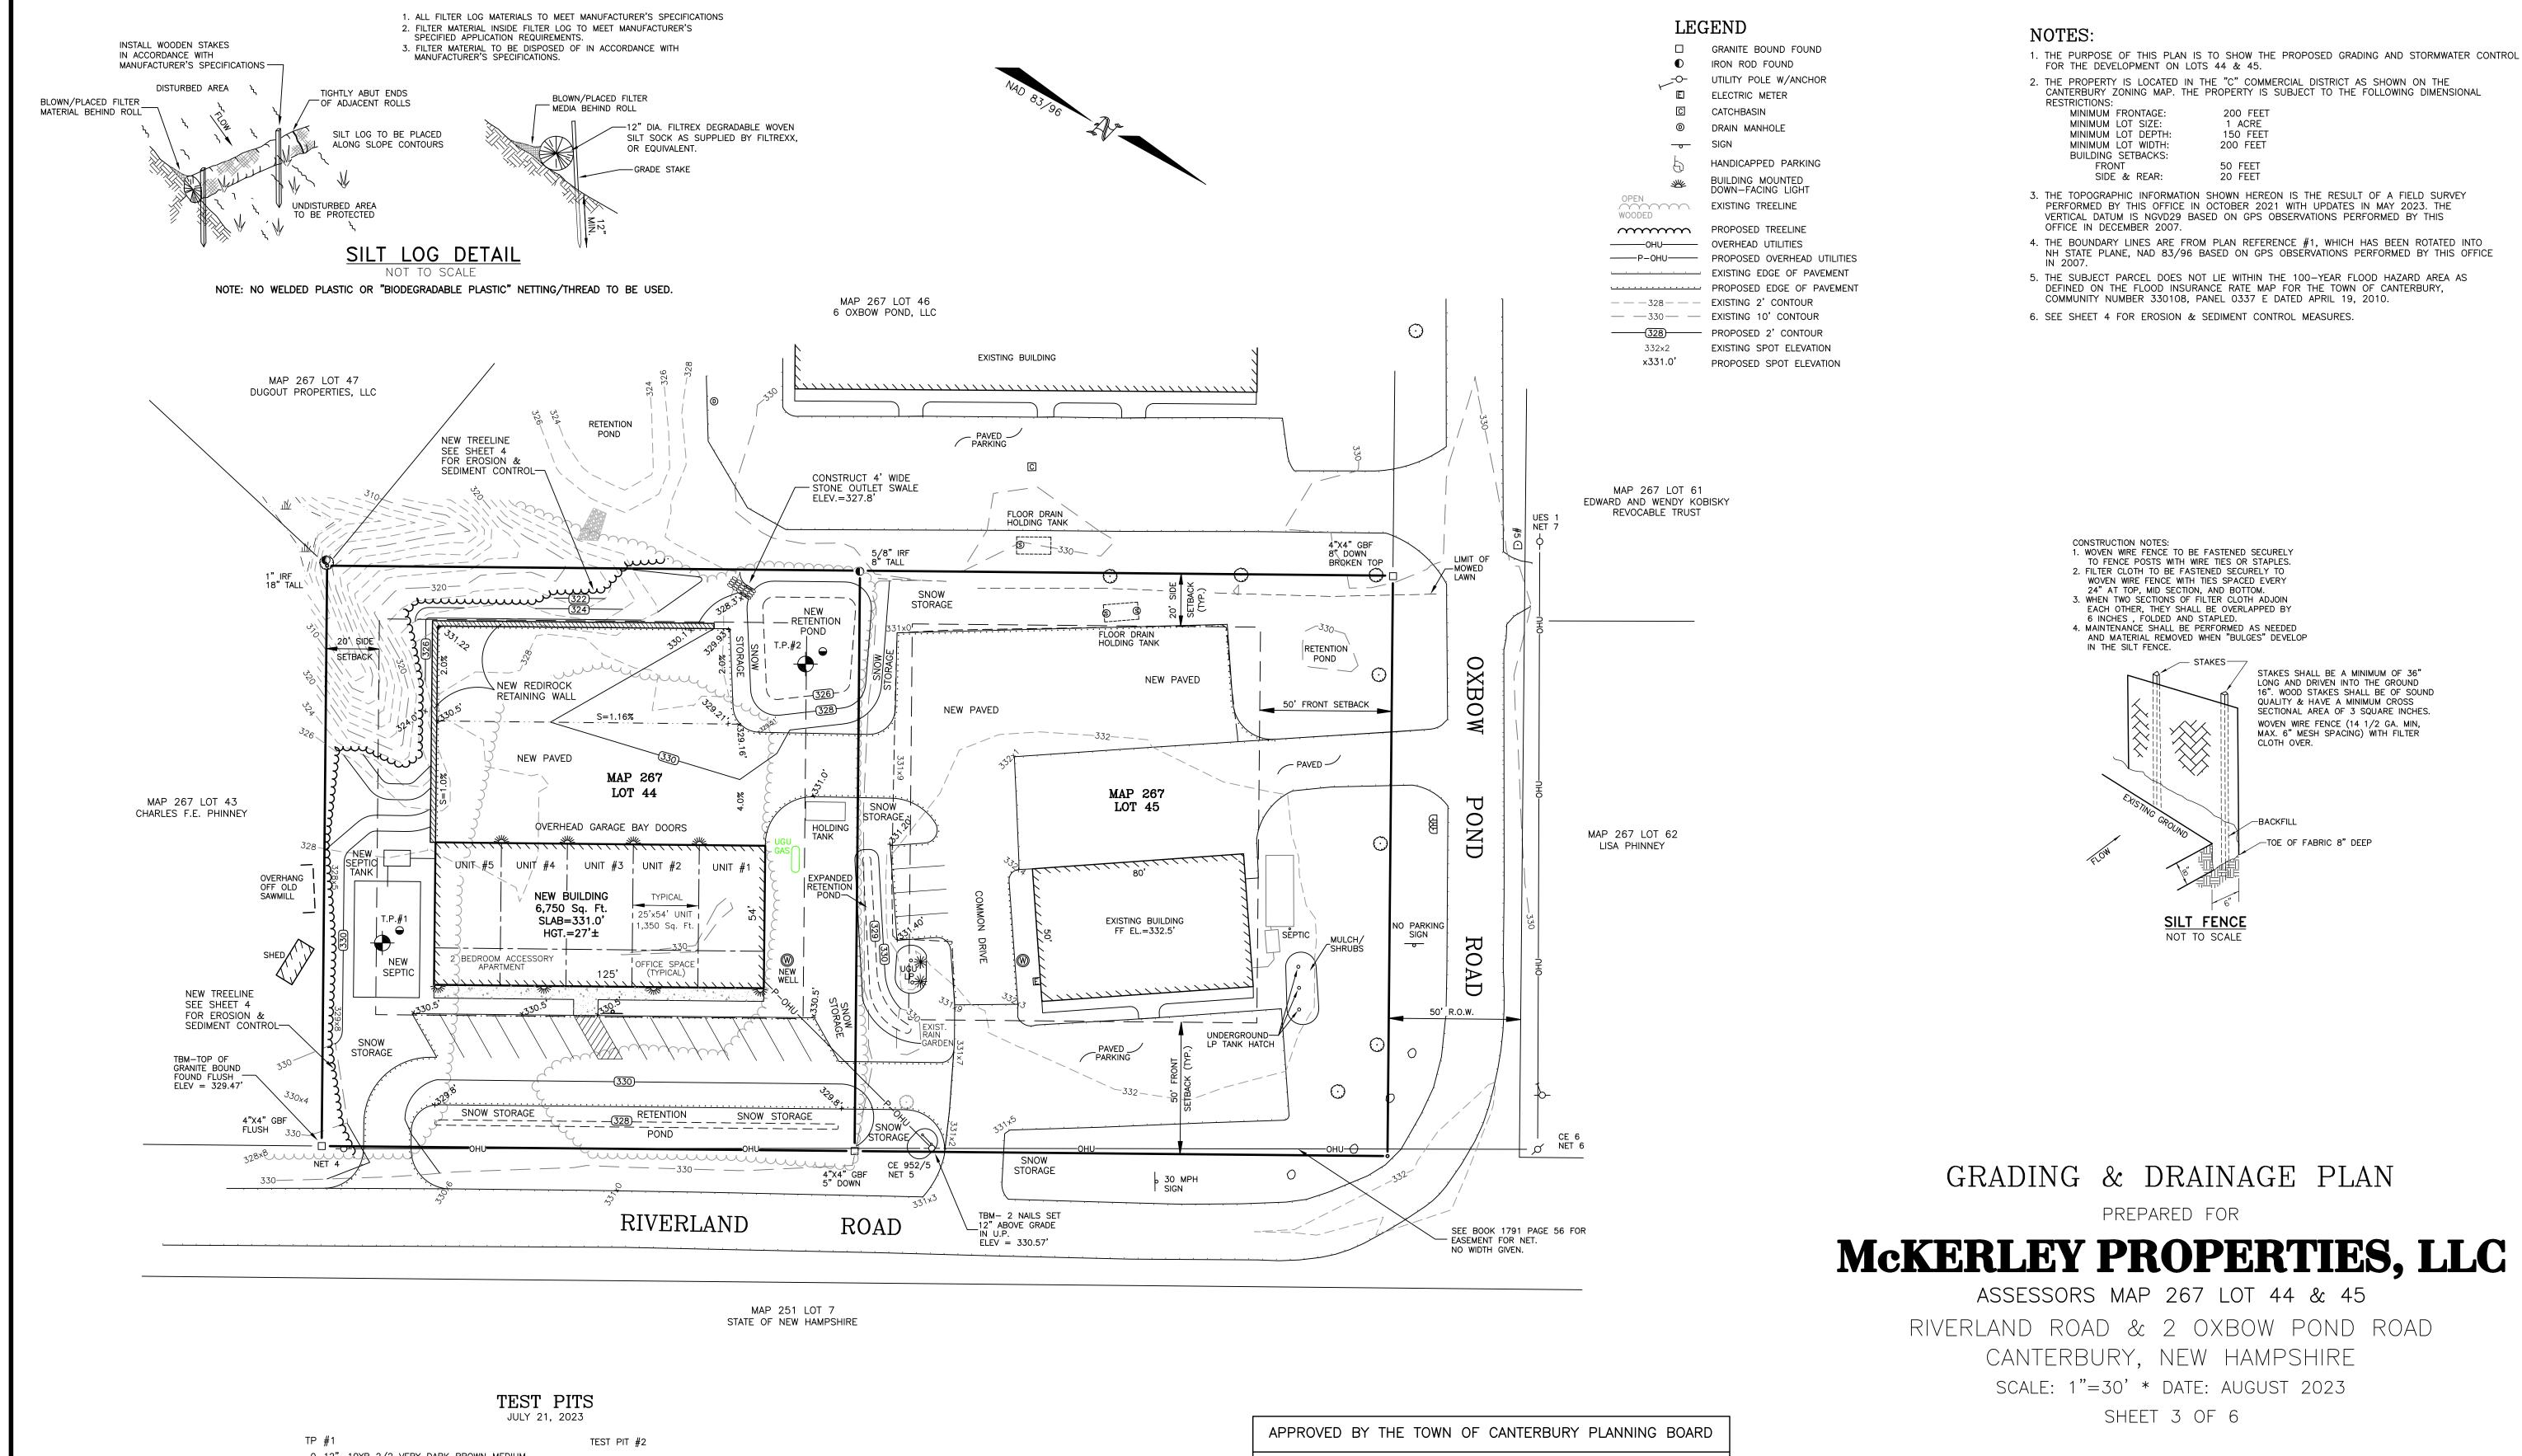

0-12" 10YR 2/2 VERY DARK BROWN MEDIUM SANDY LOAM, LOOSE, GRANULAR

10YR 5/6 YELLOWISH BROWN MEDIUM LOAMY SAND, LOOSE, GRANULAR 27-44" 10YR 6/4 LIGHT YELLOWISH BROWN MEDIUM SAND, LOOSE, GRANULAR 44-70" 10YR 6/2 LIGHT BROWNISH GRAY MEDIUM SAND, LOOSE, GRANULAR

ROOTS TO 44" NO WATER FOUND NO LEDGE FOUND TERMINATED AT 70" PERC RATE 6 MIN/INCH AT 30"

0-8" 10YR 2/2 VERY DARK BROWN MEDIUM SANDY LOAM, LOOSE, GRANULAR 8-22" 10YR 6/8 BROWNISH YELLOW MEDIUM LOAMY SAND, LOOSE, GRANULAR 22-72" 10YR 6/3 PALE BROWN COARSE SAND, LOOSE, GRANULAR

ESHWT >72" ROOTS TO 48" NO WATER FOUND NO LEDGE FOUND TERMINATED AT 72" PERC RATE 2 MIN/INCH AT 60"

SOILS FROM THE NRCS WEB SOIL SURVEY 35A- CHAMPLAIN LOAMY FINE SAND, 0-3% SLOPES. SOMEWHAT EXCESSIVELY DRAINED, HSG A

# GRAPHIC SCALE 15 0 15 30

REVISION


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# T. F. BERNIER, INC.


Land Surveyors - Designers - Consultants 50 PLEASANT STREET - P.O. BOX 3464 CONCORD, NEW HAMPSHIRE 03302-3464 Tel:(603)224-4148 - Fax:(603)224-0507


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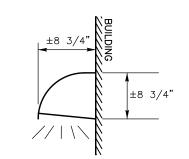
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SIGNS SHALL MEET THE REQUIREMENTS OF THE MANUAL ON UNIFORM TRAFFIC CONTROL (MUTC) DEVICES FOR STREETS AND HIGHWAYS, PUBLISHED BY THE U.S. DEPARTMENT OF TRANSPORTATION, FEDERAL HIGHWAY ADMINISTRATION. THE SIGN POST SHOULD CONFORM TO NHDOT SPECIFICATION 615.2.5.3 AND SHOULD NOT BE SET IN CONCRETE.

> HANDICAPPED PARKING SIGN DETAIL

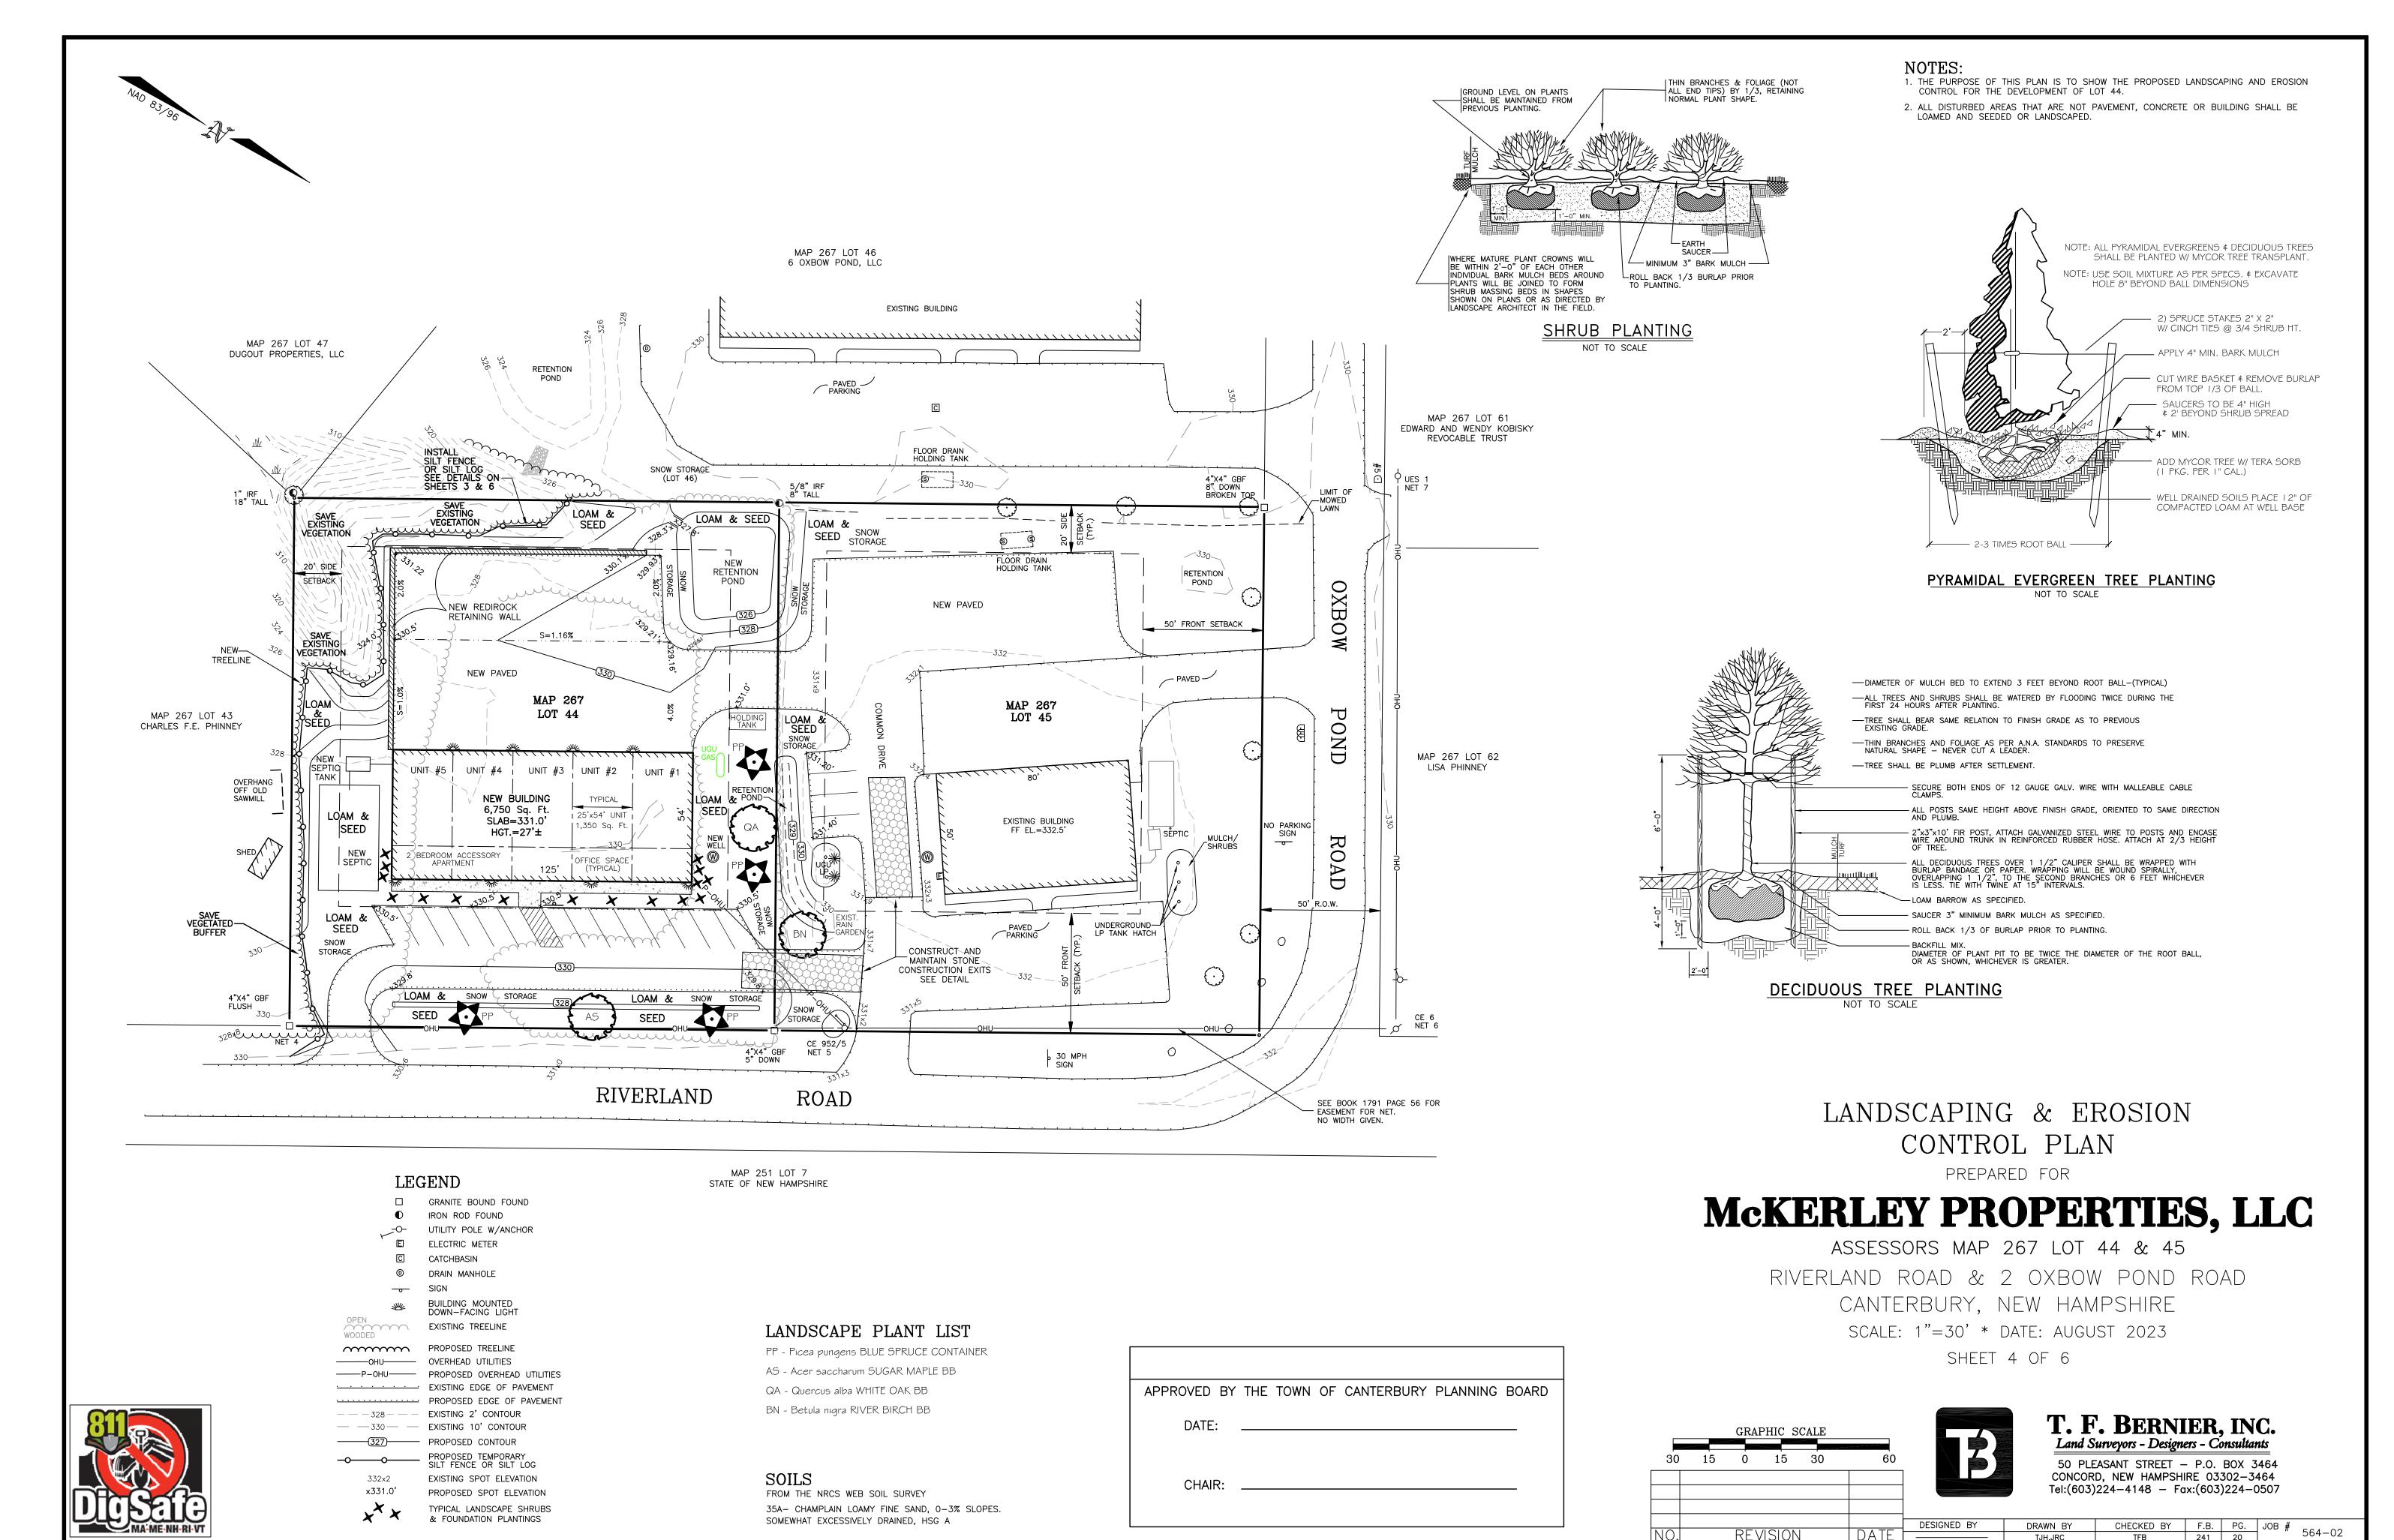

TYPICAL FULL-CUTOFF, WALL MOUNTED, DOWN-FACING LIGHT. EXTERIOR LIGHTS SHALL BE DARK SKY COMPLIANT.
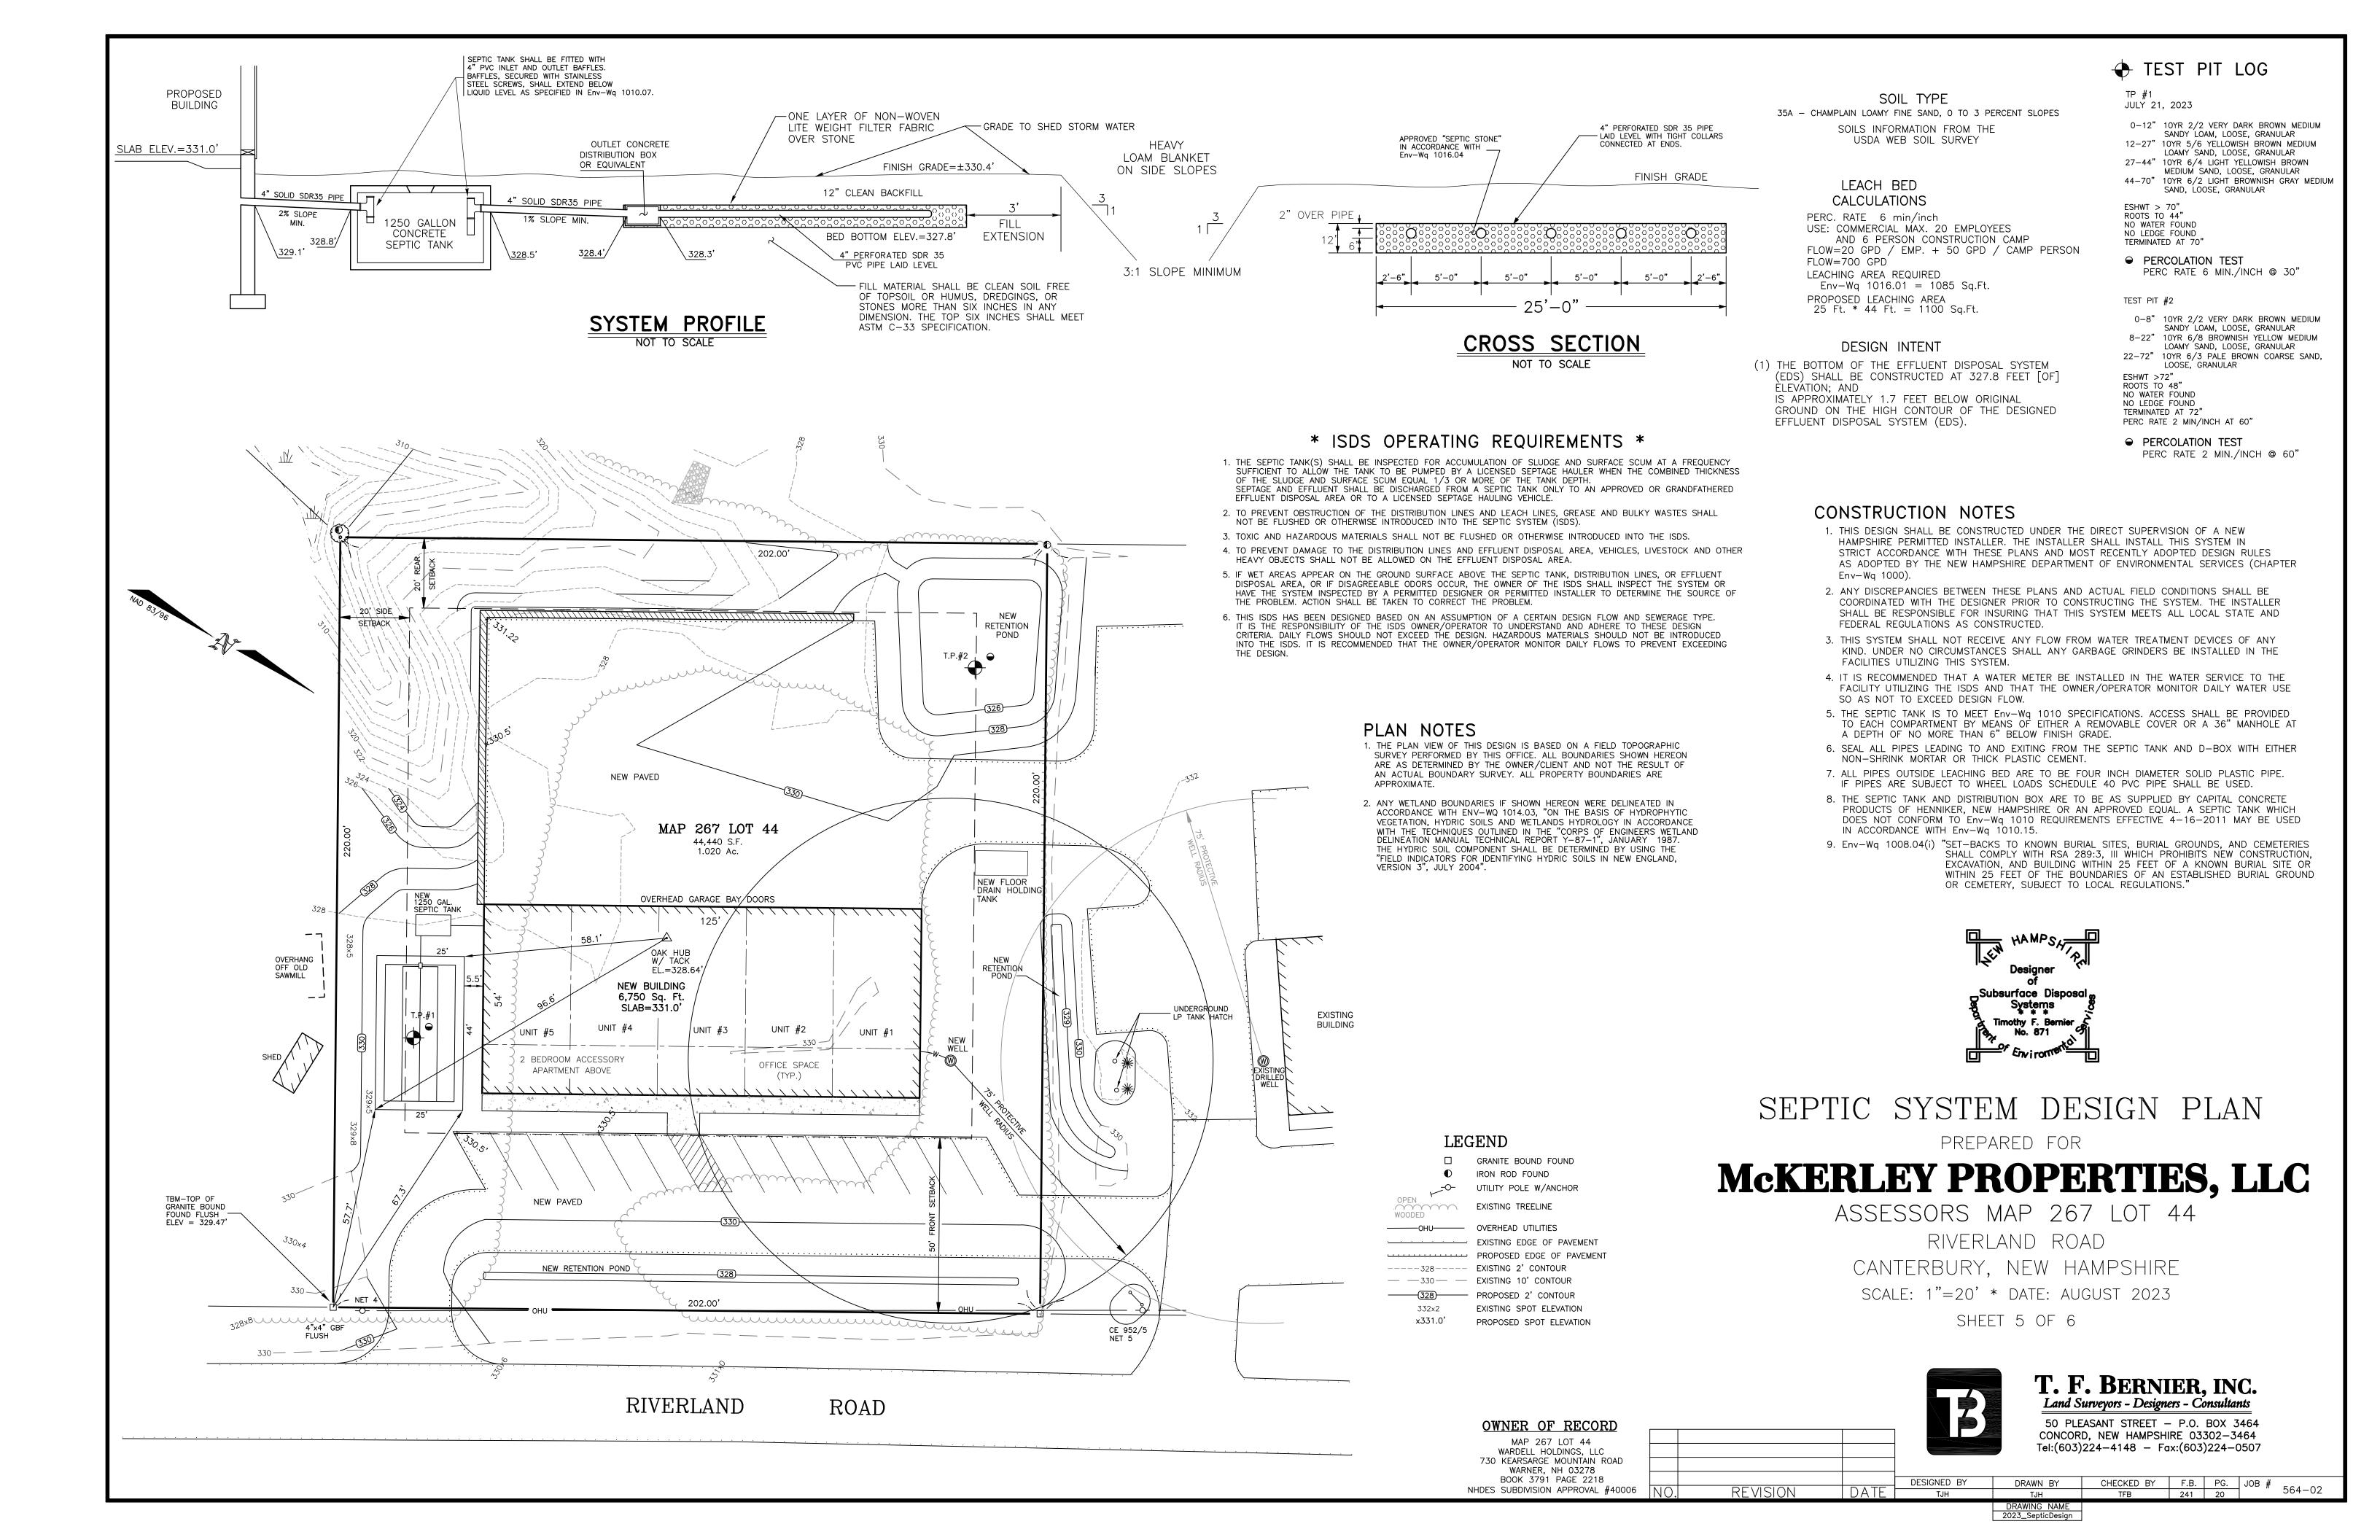
> TYPICAL WALL MOUNTED OUTDOOR LIGHT DETAIL
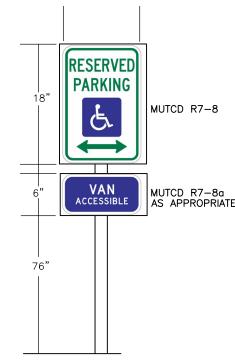
### WINTER WEATHER STABILIZATION

GENERAL REQUIREMENT:

IF THE CONSTRUCTION IS NOT COMPLETED INCLUDING THE FINAL GRADING AND SURFACE TREATMENT AND THE ESTABLISHMENT OF 85% MATURE VEGETATION COVER BY OCTOBER 15th, THEN WINTER WEATHER STABILIZATION AND CONSTRUCTION PRACTICES SHALL BE FOLLOWED. THE WINTER CONSTRUCTION PERIOD IS FROM OCTOBER 15 THROUGH MAY 15.

- 1. NO MORE THAN ONE ACRE OF THE SITE SHALL BE EXPOSED (OPEN EXCAVATION) AT ANY ONE TIME. THE EXPOSED AREA SHALL BE LIMITED TO ONLY THOSE AREAS IN WHICH WORK WILL OCCUR DURING THE FOLLOWING 15 DAYS AND THAT CAN BE MULCHED IN ONE DAY PRIOR TO ANY SNOW OR RAINFALL EVENT.
- 2. ALL EROSION AND SEDIMENT CONTROL MEASURES INSTALLED FOR THE PROJECT SHALL HAVE ROUTINE MAINTENANCE AND CLEANING COMPLETED AND SHALL BE INSPECTED AND REPAIRED AS NEEDED IN PREPARATION FOR THE CONSTRUCTION
- 3. SNOW SHALL BE REARED FROM FLOW DEPENDENT STRUCTURES TO PREVENT ICE DAMS AND SNOW BACKS FROM DIRECTING FLOW INTO AREAS NOT INTENDED OR DESIGNED / CONSTRUCTED TO RECEIVE STORM WATER.
- 4. STABILIZATION AS FOLLOWS SHALL BE COMPLETED WITHIN A DAY OF ESTABLISHING THE GRADE THAT IS FINAL OR THAT WILL EXIST FOR MORE THAN 5 DAYS: ALL PROPOSED VEGETATED AREAS HAVING A SLOPE LESS THAN 15% WHICH DO NOT EXHIBIT 85% VEGETATIVE GROWTH BY OCTOBER 15TH OR WHICH ARE DISTURBED AFTER OCTOBER 15TH SHALL BE SEEDED AND COVERED WITH 3

ALL PROPOSED VEGETATED AREAS HAVING SLOPES GREATER THAN 15% WHICH DO NOT EXHIBIT A MINIMUM OF 85% VEGETATIVE GROWTH BY OCTOBER 15TH OR ARE DISTURBED AFTER OCTOBER 15TH, SHALL BE SEEDED AND COVERED WITH AN EROSION CONTROL BLANKET AS SPECIFIED HEREON.


TO 4 TONS OF HAY OR STRAW MULCH PER ACRE SECURED WITH NETTING.

- 5. ALL GRASS LINED DITCHES SHALL BE CONSTRUCTED AND STABILIZED PRIOR TO SEPTEMBER 1ST. ANY DITCH OR SWALE WHICH DOES NOT EXHIBIT 85% VEGETATIVE GROWTH BY OCTOBER 15TH SHALL BE TEMPORARILY STABILIZED WITH STONE OR EROSION CONTROL BLANKETS. STONE SHALL BE SIZED BY THE ENGINEER.
- 6. AFTER NOVEMBER 15TH INCOMPLETE DRIVEWAY OR PARKING AREAS WHERE ACTIVE CONSTRUCTION HAS STOPPED FOR WINTER SHALL BE PROTECTED WITH A MINIMUM 3 INCH LAYER OF CRUSHED GRAVEL WITH A GRADATION SUCH THAT LESS THAN 12% OF THE SAND PORTION, (MATERIAL PASSING THE #4 SIEVE) BY WEIGHT PASSES
- 7. SILT FENCES SHALL NOT BE INSTALLED ON FROZEN GROUND WHEN THEY CAN NOT BE PROPERLY EMBEDDED. IN THE EVENT THAT GROUND HAS FROZEN, "EROSION CONTROL MIX BERMS" OR AN APPROVED FILTER SOCK SHALL BE USED.

### RETENTION BASIN CONTRUCTION


- 1. DO NOT DISCHARGE SEDIMENT-LADEN WATERS FROM CONSTRUCTION ACTIVITIES (RUNOFF, WATER FROM EXCAVATIONS) TO THE INFILTRATION BASINS.
- 2. DO NOT TRAFFIC & COMPACT THE BASIN FLOORS WITH CONSTRUCTION EQUIPMENT, IF FEASIBLE, CONSTRUCT EXCAVATIONS WITH EQUIPMENT POSITIONED OUTSIDE THE LIMITS OF THE INFILTRATION BASIN.
- 3. AFTER THE BASIN IS EXCAVATED TO THE FINAL DESIGN ELEVATION, THE FLOOR SHOULD BE DEEPLY TILLED WITH A ROTARY TILLER OR DISC HARROW TO RESTORE INFILTRATION RATES, FOLLOWED BY A PASS WITH A LEVELING DRAG.
- 4. VEGETATION SHOULD BE ESTABLISHED ON SLOPES IMMEDIATELY.
- 5. DO NOT PLACE INFILTRATION SYSTEM INTO SERVICE UNTIL THE CONTRIBUTING AREAS HAVE BEEN FULLY STABILIZED.




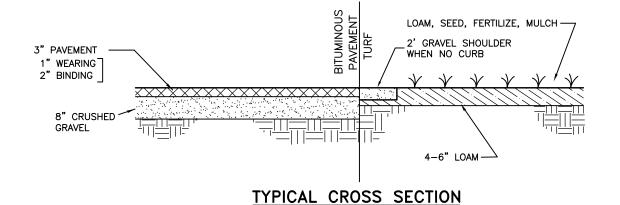

CONSTRUCTION NOTES: 1. WOVEN WIRE FENCE TO BE FASTENED SECURELY TO FENCE POSTS WITH WIRE TIES OR STAPLES 2. FILTER CLOTH TO BE FASTENED SECURELY TO WOVEN WIRE FENCE WITH TIES SPACED EVERY

- 24" AT TOP, MID SECTION, AND BOTTOM.
  3. WHEN TWO SECTIONS OF FILTER CLOTH ADJOIN EACH OTHER, THEY SHALL BE OVERLAPPED BY
- 6 INCHES , FOLDED AND STAPLED. 4. MAINTENANCE SHALL BE PERFORMED AS NEEDED

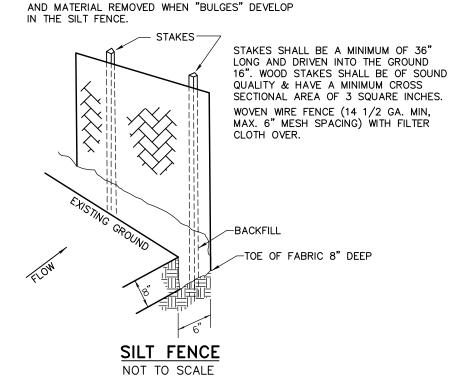

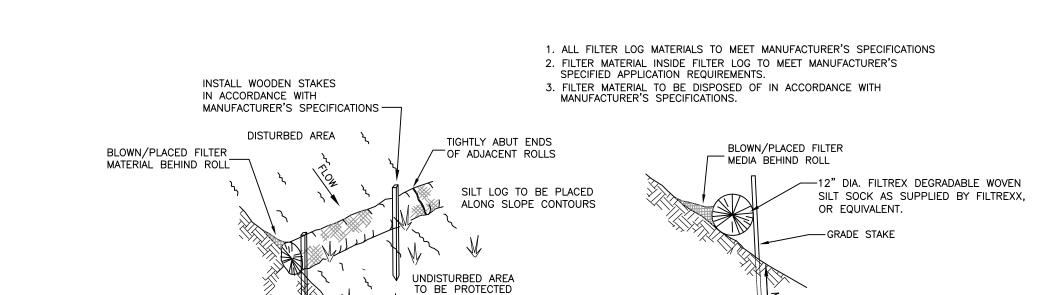

NOTE: NO WELDED PLASTIC OR "BIODEGRADABLE PLASTIC" NETTING/THREAD TO BE USED.

SILT LOG DETAIL

### GENERAL CONSTRUCTION AND EROSION CONTROL NOTES

- 1. THE CONTRACTOR SHALL COORDINATE ANY DISCREPANCIES BETWEEN THESES PLANS AND ACTUAL FIELD CONDITIONS WITH THIS OFFICE. THE CONTRACTOR SHALL BE RESPONSIBLE FOR PERFORMING ALL ASPECTS OF CONSTRUCTION IN ACCORDANCE WITH
- 2. ALL CONSTRUCTION METHODS AND MATERIALS SHALL BE IN ACCORDANCE WITH THE APPROPRIATE SECTION OF THE STATE OF NEW HAMPSHIRE STANDARD SPECIFICATIONS FOR ROAD AND BRIDGE CONSTRUCTION AND THE REGULATIONS OF THE TOWN OF CANTERBURY.
- 3. ALL CONSTRUCTION SHALL BE PERFORMED IN ACCORDANCE WITH THESE PLANS AND THE BEST MANAGEMENT PRACTICES AS ACCEPTED BY THE STATE OF NEW HAMPSHIRE. 3A. THE SMALLEST PRACTICAL AREA SHALL BE DISTURBED AT ONE TIME DURING THE CONSTRUCTION PROCESS. THE AREA OF UNSTABILIZED SOIL SHALL NOT EXCEED
- 4. THE CONTRACTOR SHALL BE RESPONSIBLE FOR OBTAINING ALL REQUIRED LOCAL, STATE AND FEDERAL CONSTRUCTION PERMITS AND APPROVALS PRIOR TO BEGINNING CONSTRUCTION.
- LOCATION OF ALL UNDERGROUND UTILITIES PRIOR TO COMMENCING EXCAVATION.
- 6. THE CONTRACTOR SHALL COORDINATE WITH ALL PERTINENT UTILITY COMPANIES FOR THE LOCATION AND INSTALLATION OF UTILITIES.
- 7. ALL SLOPES GREATER THAN 3:1 SHALL BE TREATED WITH EROSION CONTROL BLANKETS AS MANUFACTURED BY NORTH AMERICAN GREEN AND SUPPLIED BY ARTHUR WHITCOMB—TILCON OF KEENE, NEW HAMPSHIRE. ALL SLOPES SHALL BE LOAMED SEEDED AND TREATED WITHIN 72 HOURS OF THEIR COMPLETION.

SLOPES FROM 3:1 TO 2:1 - USE S150 STRAW BLANKETS, OR EQUIVALENT. SLOPES FROM 2:1 TO 1:1 - USE SC150 STRAW/COCONUT BLANKETS, OR EQUIVALENT. 8. COMPACTION:

- A. GRASSED AREAS: EMBANKMENT FILL AREAS SHALL CONSIST OF COMMON FILL PLACED IN 12 INCH LIFTS AND COMPACTED TO 95%
- B. PAVED DRIVEWAY/PARKING AREAS: THE COMPACTION REQUIREMENTS FOR MATERIAL PLACED BENEATH THE ROAD SHALL BE AS SPECIFIED IN THE NEW HAMPSHIRE DEPARTMENT OF TRANSPORTATION STANDARD SPECIFICATION FOR ROAD
- 9. ALL DISTURBED AREAS SHALL BE COMPLETED AND PERMANENTLY STABILIZED WITHIN 45 DAYS OF THEIR INITIAL DISTURBANCE; ANY DISTURBED AREA SHALL BE STABILIZED WITHIN 72 HOURS OF ACHIEVING FINISHED GRADE.
- 9A. AN AREA SHALL BE CONSIDERED "STABLE" IF ONE OF THE FOLLOWING HAS OCCURRED: 1. BASE COURSE GRAVELS HAVE BEEN INSTALLED IN AREAS TO BE PAVED. 2. A MINIMUM OF 85% VEGETATED GROWTH HAS BEEN ESTABLISHED. 3. A MINIMUM OF 3" OF NON-EROSIVE MATERIAL SUCH AS STONE RIP-RAP HAS
- 4. OR, EROSION CONTROL BLANKETS HAVE BEEN INSTALLED.
- 10. THE CONTRACTOR SHALL MAINTAIN A MECHANISM TO WATER ALL DISTURBED AREAS AS A MEANS OF DUST CONTROL THROUGHOUT CONSTRUCTION

### CONSTRUCTION SEQUENCE

- 1. INSTALL SILT FENCE AND STABILIZED CONSTRUCTION EXIT AS SHOWN ON PLANS.
- 2. STRIP LOAM AS NECESSARY AND STOCKPILE ON SITE.
- 3. CONSTRUCT BASINS AND PERMANENT STORMWATER CONVEYANCE SWALES. ALL GRASS LINED SWALES, RETENTION AREAS AND AND GRASSED AREAS/SLOPES SHALL BE PROTECTED FROM STORMWATER RUNOFF UNTIL VEGETATION IS SUBSTANTIALLY ESTABLISHED OR AREAS
- 4. CUT AND FILL PARKING AREAS TO SUBGRADE. CUT AND FILL OTHER AREAS AND STABILIZE ALL SLOPES AS SPECIFIED.
- 5. INSTALL ALL UNDERGROUND UTILITIES. 6. PLACE CRUSHED GRAVEL, PAVE DRIVEWAY AND PARKING AS SPECIFIED. STABILIZE ALL
- DISTURBED AREAS. 7. COMPLETE FINAL SEEDING, REPAIR ANY DAMAGED OR ERODED AREAS.
- 8. REMOVE TEMPORARY EROSION AND SEDIMENT CONTROL FACILITIES. REPAIR

### MAINTENANCE RESPONSIBILITIES

DISTURBED AREAS.

- A. THE CONTRACTOR SHALL INSPECT ALL EROSION CONTROL WEEKLY AND AFTER EVERY RAINFALL OF 1/2" OR MORE WITHIN A 24 HOUR PERIOD. ANY DAMAGED, FAILING OR IMPROPER EROSION CONTROL MEASURES FOUND DURING THE INSPECTION SHALL BE REPAIRED IMMEDIATELY.
- B. THE CONTRACTOR SHALL CONSTRUCT TEMPORARY BERMS DRAINAGE DITCHES, SILT FENCE, SEDIMENT TRAPS ETC. AS NEEDED DURING CONSTRUCT TO CONTROL STORM WATER AND MINIMIZE EROSION.
- C. INSPECT VEGETATION GROWTH AND REMOVE INVASIVE SPECIES AS NECESSARY.

### SEEDING SPECIFICATIONS

- ALL DISTURBED AREAS TO BE SEEDED SHALL BE TREATED AS
- A MINIMUM OF 4" OF TOPSOIL SHALL BE PLACED

FOLLOWS:

- ON ALL DISTURBED AREAS. - 10-20-20 FERTILIZER SHALL BE PLACED AT A
- RATE OF 500 LBS. PER ACRE - IN THE ABSENCE OF A SOIL TEST, APPLY LIMESTONE
- AT A RATE OF 3 TONS/Ac., (138 LBS./1000 SQ. FT.). - THE FOLLOWING SEED MIXTURE SHALL BE SPREAD
- EVENLY OVER THE TOPSOIL AT THE RATES SHOWN. POUNDS/Sq. Ft. POUNDS/ACRE

TALL FESCUE CREEPING RED FESCUE BIRDSFOOT TREFOIL TOTAL 1.10 WORK LIME AND FERTILIZER INTO SOIL TO A DEPTH OF

- ROUGHLY 4", TRACK UP/DOWN SLOPES WITH BULLDOZER TO FORM HORIZONTAL GROOVES TO CATCH SEED AND WATER.
- HAY. STRAW OR OTHER MULCH SHALL BE APPLIED
- IMMEDIATELY AFTER SEEDING.
- ALL SEEDING SHALL BE COMPLETED BEFORE JUNE 1ST IN THE SPRING OR BETWEEN AUGUST 15TH AND SEPTEMBER 15TH IN THE FALL. SEEDING MAY EXTEND INTO JUNE AND JULY IF CONSIDERATIONS ARE MADE FOR WATERING.

### TEMPORARY SEEDING SPECIFICATIONS

TEMPORARY VEGETATIVE COVER SHOULD BE APPLIED WHERE EXPOSED SOIL SURFACES WILL NOT BE FINAL GRADED WITHIN 45 DAYS FROM INITIAL DISTURBANCE. THE FOLLOWING ARE SUGGESTED SEEDING APPLICATIONS:

POUNDS/1000 Sq. Ft. <u>SPECIES</u> POUNDS/ACRE WINTER RYE 112 2.5 OATS ANNUAL RYEGRASS PERENNIAL RYEGRASS 30 0.7

- TEMPORARY SEEDING SHOULD OCCUR PRIOR TO SEPTEMBER 15. - AREAS SEEDED BETWEEN MAY 15 AND AUGUST 15 SHOULD BE COVERED WITH HAY OR STRAW MULCH.

APPROVED BY THE TOWN OF CANTERBURY PLANNING BOARD

- ALSO SEE WINTER WEATHER STABILIZATION NOTES.

CHAIR:

### CONSTRUCTION DETAILS

PREPARED FOR

### McKERLEY PROPERTIES, LLC

MAX. 30 FT. HIGH

**STOCKPILED** 

BASE RECESSED 1 FT

MATERIAL

1. MATERIAL SHALL NOT BE STOCK PILED WITHIN 100' OF ANY WETLAND OR 50' OF CONCENTRATED FLOWS OF STORMWATER, DRAINAGE COURSES AND

2. CONSTRUCT DIVERSION BERM ALONG UP SLOPE SIDE OF STOCKPILE TO

3. INACTIVE STOCKPILES SHALL BE COVERED WITH TARPS OR SEEDED AND MULCHED. SILT FENCE BARRIERS SHALL BE MAINTAINED AT ALL TIMES.

TYPICAL MATERIAL STOCKPILE

NOT TO SCALE

MOUNTABLE DIVERSION BERM MANDATORY FOR 50' EXIT — OPTIONAL FOR 75' EXIT.

3"-6" HIGH OR GREATER

**PROFILE** 

MIN. 3" DIAM. COARSE ≺ AGGREGATE. MIN. 6" THICK

PLAN VIEW

STONE SIZE — USE 3" STONE, OR RECLAIMED OR RECYCLED CONCRETE EQUIVALENT.

LENGTH —AS REQUIRED, BUT NOT LESS THAN 50 FEET (EXCEPT ON A SINGLE RESIDENCE
LOT WHERE A 30 FOOT MINIMUM LENGTH WOULD APPLY).

THICKNESS — NOT LESS THAN SIX (6) INCHES.

WIDTH — TEN (10) FOOT MINIMUM, BUT NOT LESS THAN THE FULL WIDTH AT POINTS

WHERE INGRESS OR EGRESS OCCURS.

FILTER CLOTH — WILL BE PLACED OVER THE ENTIRE AREA PRIOR TO PLACING OF STONE.

MOUNTABLE BERM WITH 5:1 SLOPES WILL BE PERMITTED.

MAINTENANCE — THE ENTRANCE SHALL BE MAINTAINED IN A CONDITION WHICH WILL

PREVENT TRACKING OR FLOWING OF SEDIMENT ONTO PUBLIC RIGHTS—OF—WAY. THIS MAY

REQUIRE PERIODIC TOP DRESSING WITH ADDITIONAL STONE AS CONDITIONS DEMAND AND REPAIR AND/OR CLEANOUT OF ANY MEASURES USED TO TRAP SEDIMENT. ALL SEDIMENT SPILLED, DROPPED, WASHED, OR TRACKED ONTO PUBLIC RIGHTS—OF—WAY MUST BE

PUBLIC RIGHTS-OF-WAY. WHEN WASHING IS REQUIRED, IT SHALL BE DONE ON AN AREA

STABILIZED WITH STONE AND WHICH DRAINS INTO AN APPROVED SEDIMENT TRAPPING

9. PERIODIC INSPECTION AND NEEDED MAINTENANCE SHALL BE PROVIDED AFTER EACH RAIN.

STABILIZED CONSTRUCTION ENTRANCE

IMMEDIATELT.

WHEELS SHALL BE CLEANED TO REMOVE SEDIMENT PRIOR TO ENTRANCE ON

FILTER CLOTH WILL NOT BE REQUIRED ON A SINGLE FAMILY RESIDENCE LOT.

6. SURFACE WATER — ALL SURFACE WATER FLOWING OR DIVERTED TOWARD CONSTRUCTION ENTRANCES SHALL BE PIPED ACROSS THE ENTRANCE. IF PIPING IS IMPRACTICAL, A

PROTECT THE STOCKPILE FROM STORMWATER FLOWS.

SILT FENCE

1 1 1 1 1 1 1

REMOVED IMMEDIATELY.

CONSTRUCTION SPECIFICATIONS

1 SIDE SLOPE

SILT FENCE

ASSESSORS MAP 267 LOT 44 & 45

RIVERLAND ROAD & 2 OXBOW POND ROAD CANTERBURY, NEW HAMPSHIRE

SCALE: 1"=30' \* DATE: AUGUST 2023 SHEET 6 OF 6

### T. F. BERNIER, INC. Land Surveyors - Designers - Consultants

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CHECKED BY F.B. PG. JOB # 564-02 DESIGNED BY DRAWN BY REVISION