


APPLICANT\OWNER:
STATION MEADOW, LLC
4 DUNLAP ROAD
BURLINGTON, MA 01803

CIVIL ENGINEER /
LANDSCAPE ARCHITECT /
SURVEYOR:
ALLEN & MAJOR ASSOCIATES, INC.
400 HARVEY ROAD
MANCHESTER, NH 03103
PHONE: 603.627.5500

WETLAND / SOIL SCIENTIST:
GOVE ENVIRONMENTAL SERVICES, INC.
8 CONTINENTAL DRIVE
BUILDING 2, UNIT H
EXETER, NH 03833
PHONE: 603.778.0644

# SITE DEVELOPMENT PLANS FOR HALL ROAD

ASSESSOR'S MAP 251, LOT 18 CANTERBURY, NH 03224

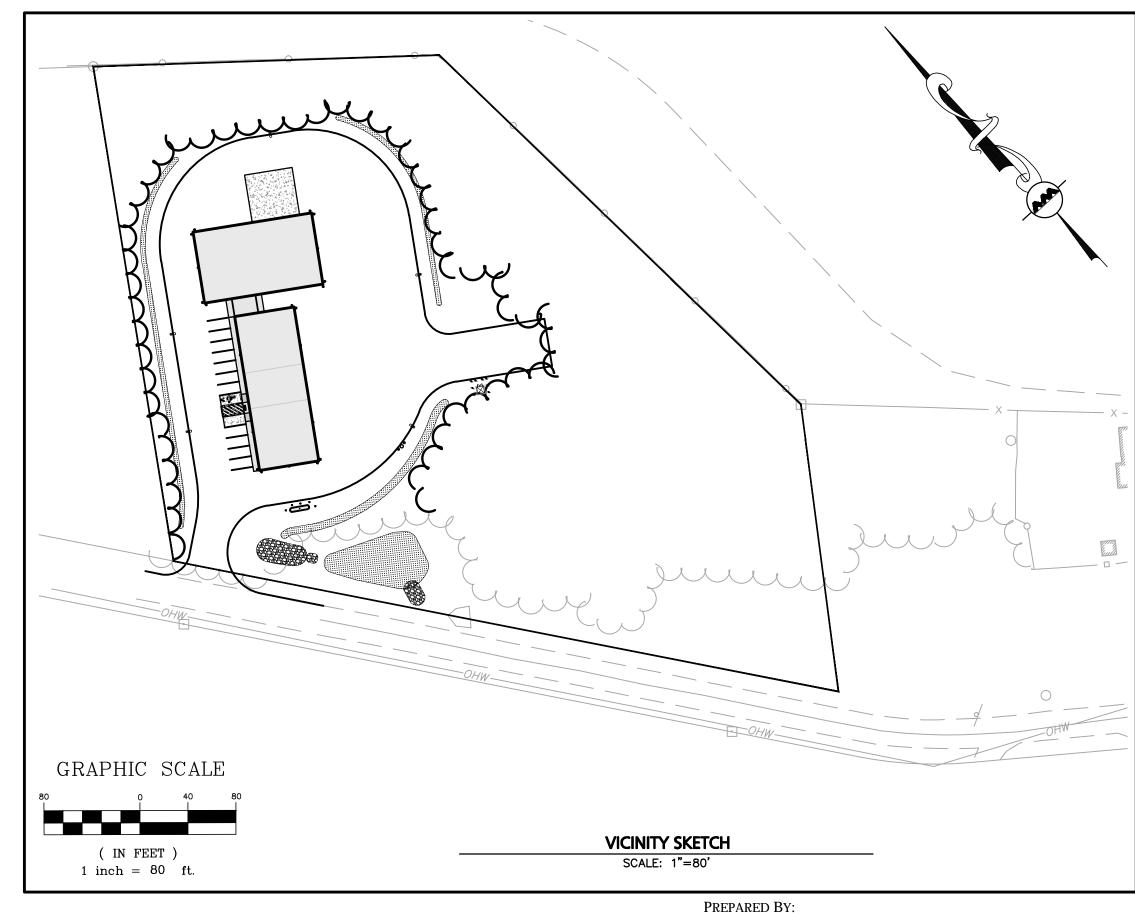

LIST OF DRAWINGS							
DRAWING TITLE	SHEET	ISSUED	REVISION I				
EXISTING CONDITIONS PLAN	V-100	05-13-21	-				
LOT LINE ADJUSTMENT PLAN	V-101	05-13-21	-				
EXISTING SOILS MAPPING	V-102	ı	-				
LAYOUT & MATERIALS PLAN	C-100	05-17-21	-				
GRADING & DRAINAGE PLAN	C-101	05-17-21	-				
UTILITIES PLAN	C-102	05-17-21	-				
EROSION CONTROL PLAN	C-103	05-17-21	-				
SITE LIGHTING PLAN	C-104	05-17-21	-				
DETAILS	C-501	05-17-21	-				
DETAILS	C-502	05-17-21	-				
DETAILS	C-503	05-17-21	-				
INDIVIDUAL SUBSURFACE DISPOSAL SYSTEM	ISDS-I	05-17-21	-				
INDIVIDUAL SUBSURFACE DISPOSAL SYSTEM	ISDS-2	05-17-21	-				
	-	•	-				



PROFESSIONAL ENGINEER FOR ALLEN & MAJOR ASSOCIATES, INC.




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FAX: (603) 627-5501

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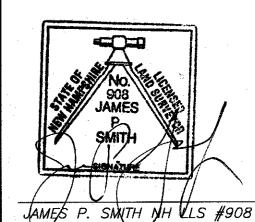
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ISSUED FOR REVIEW: MAY 17, 2021



THIS PLAN IS THE RESULT OF AN ACTUAL ON THE GROUND SURVEY PERFORMED ON OR BETWEEN MARCH 20, 2021 AND MARCH 25, 2021 AND HAD AN ERROR OF CLOSURE OF NO GREATER THAN 1/10,000.

ALLEN & MAJOR ASSOCIATES, INC.

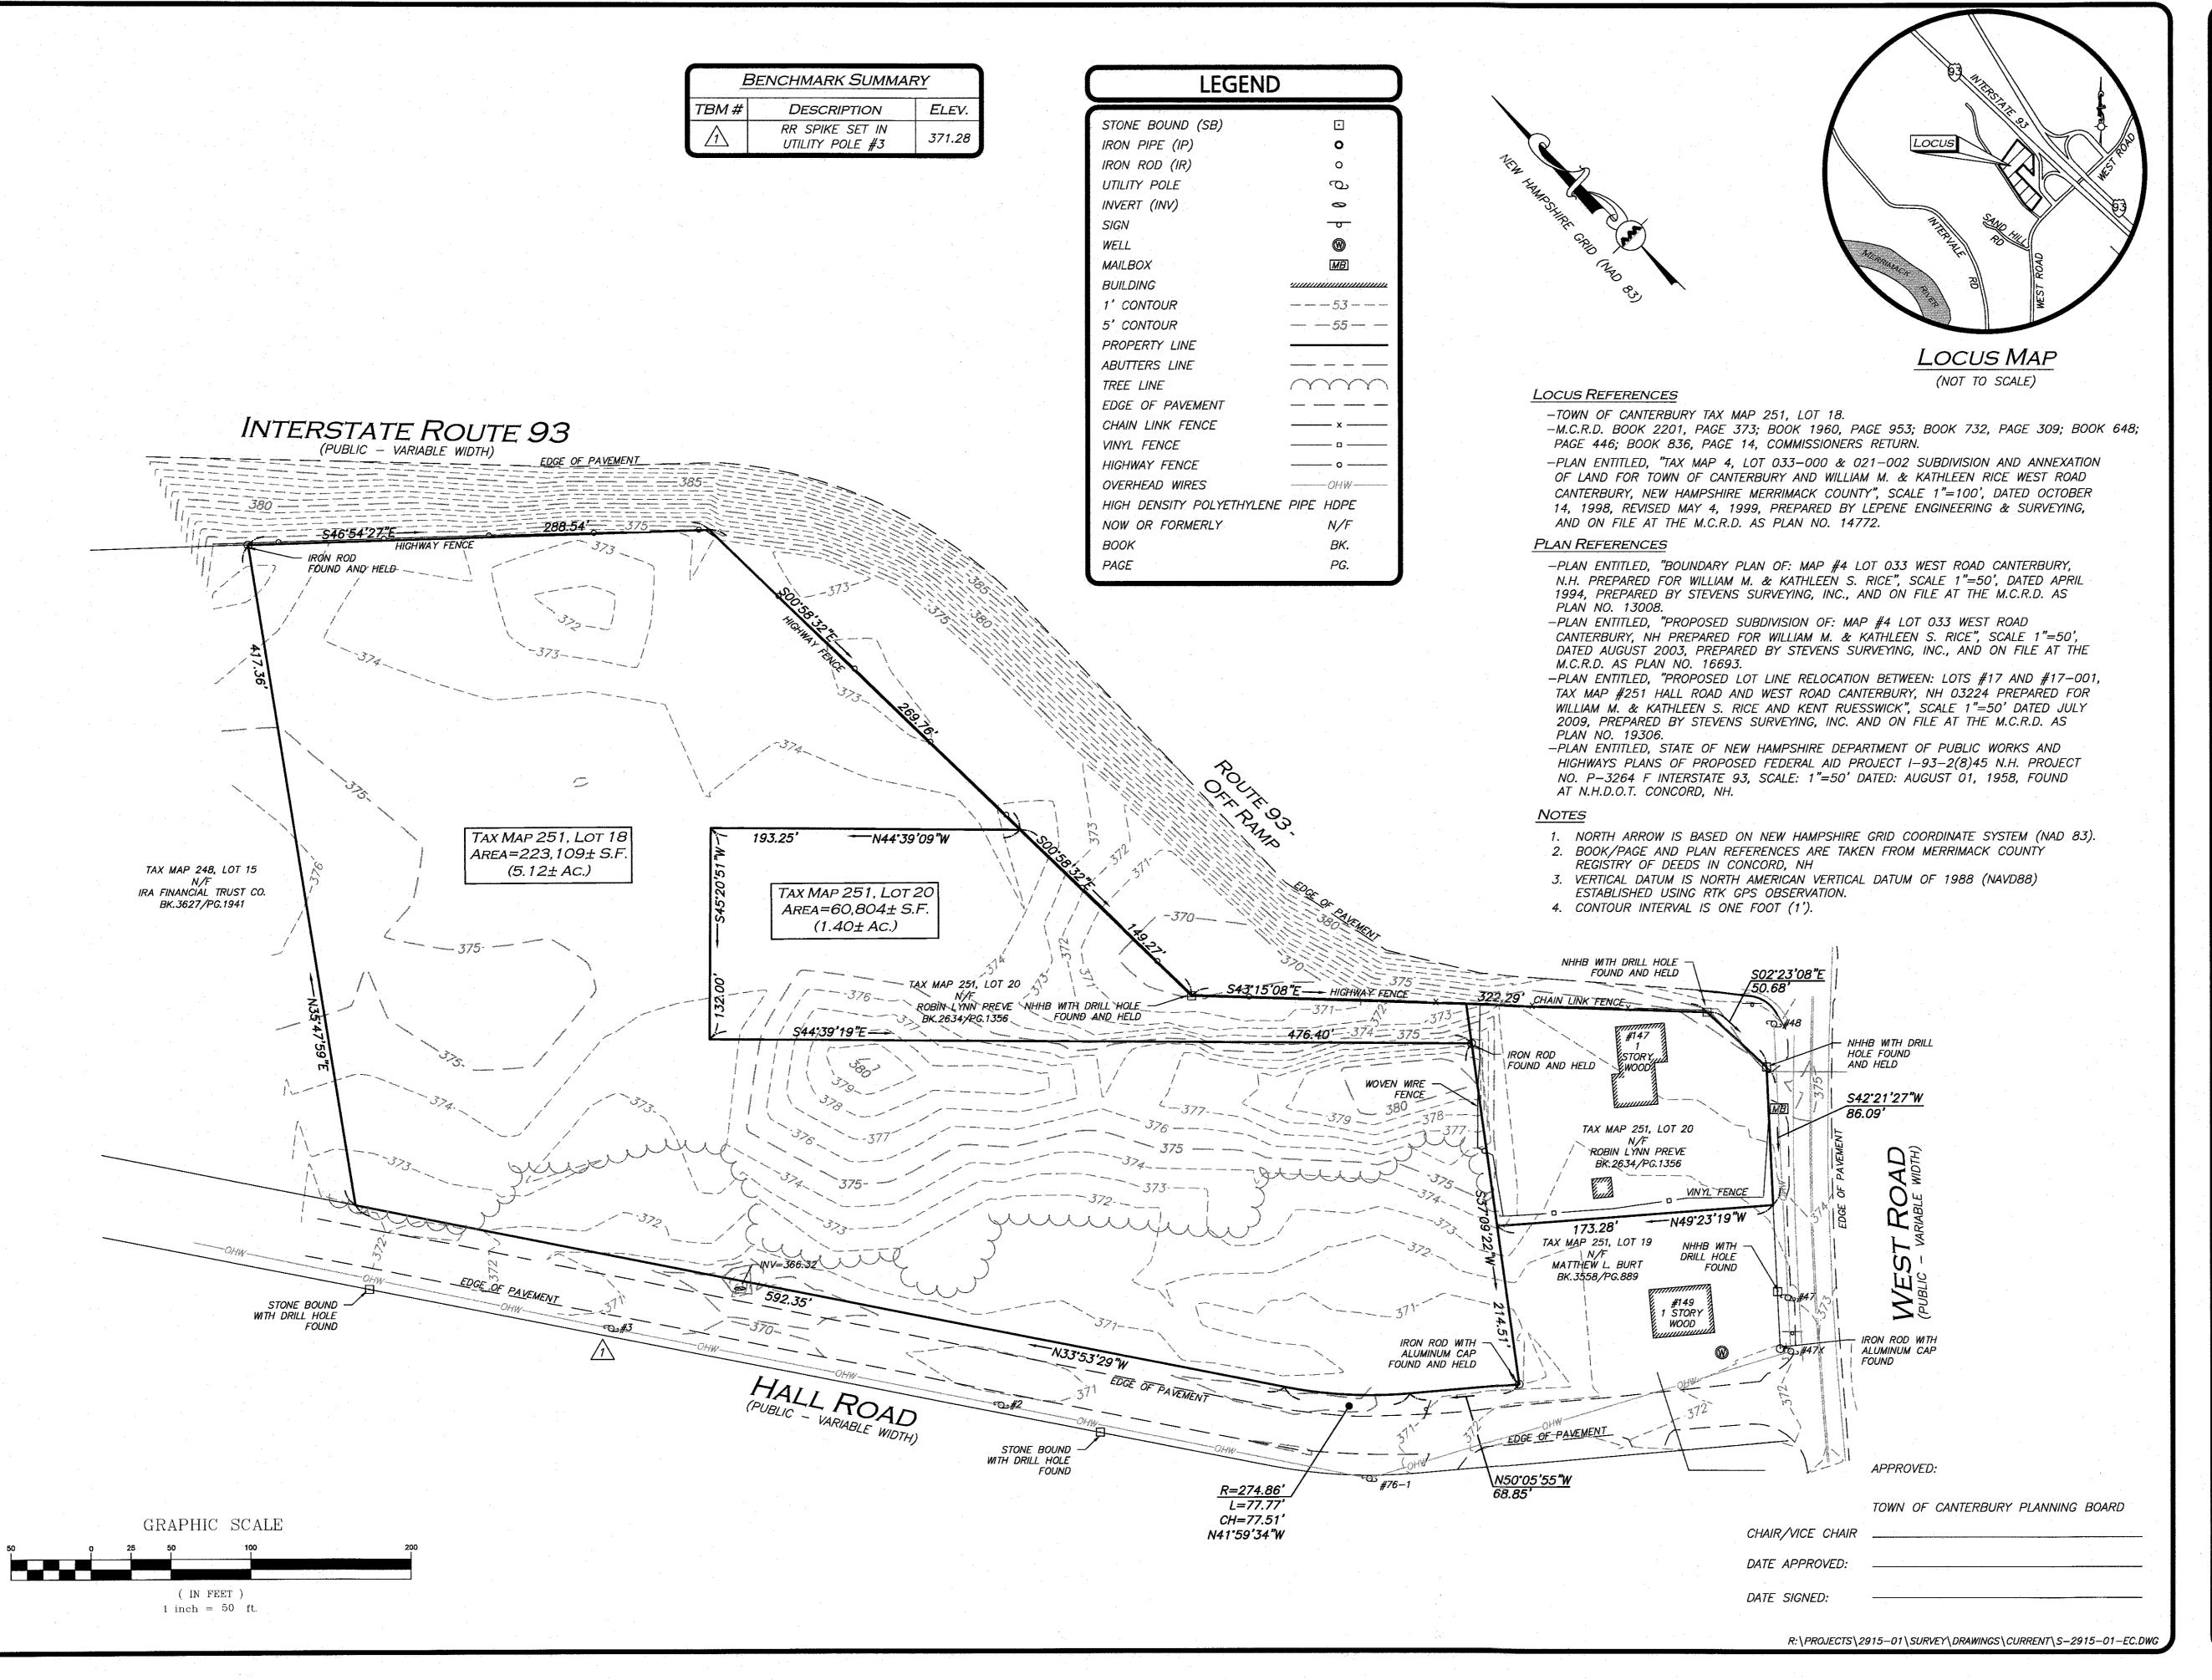

5-13-2021

DATE DESCRIPTION APPLICANT\OWNER:

STATION MEADOW, LLC 4 DUNLAP ROAD **BURLINGTON, MA 01803** 

PROJECT:

TAX MAP 251, LOT 18 HALL ROAD CANTERBURY, NH

PROJECT NO.	2915-01	DATE:	4/0
 SCALE:	1" = 50'	DWG. NAME:	S-2915-0°
DRAFTED BY:	AJR	CHECKED BY:	
PREPARED BY:			



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FAX: (603) 627-5501 WOBURN, MA ♦ LAKEVILLE, MA ♦ MANCHESTER, N


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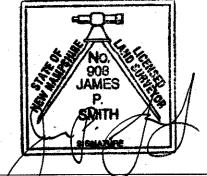
V-100

DRAWING TITLE:

**EXISTING CONDITIONS** 



"I CERTIFY THAT THIS SURVEY PLAT IS NOT A SUBDIVISION PURSUANT TO THIS TITLE AND THAT THE LINES OF STREETS AND WAYS SHOWN ARE THOSE OF PUBLIC OR PRIVATE STREETS OR WAYS ALREADY ESTABLISHED AND THAT NO NEW WAYS ARE SHOWN. THIS PLAN IS THE RESULT OF AN ACTUAL FIELD SURVEY MADE ON OR BETWEEN MARCH 20, 2021 AND MARCH 25, 2021 AND HAS A MAXIMUM ERROR OF CLOSURE OF ONE PART IN TEN THOUSAND ON ALL PROPERTY LINES WITHIN AND BORDERING THE SUBJECT PROPERTY."

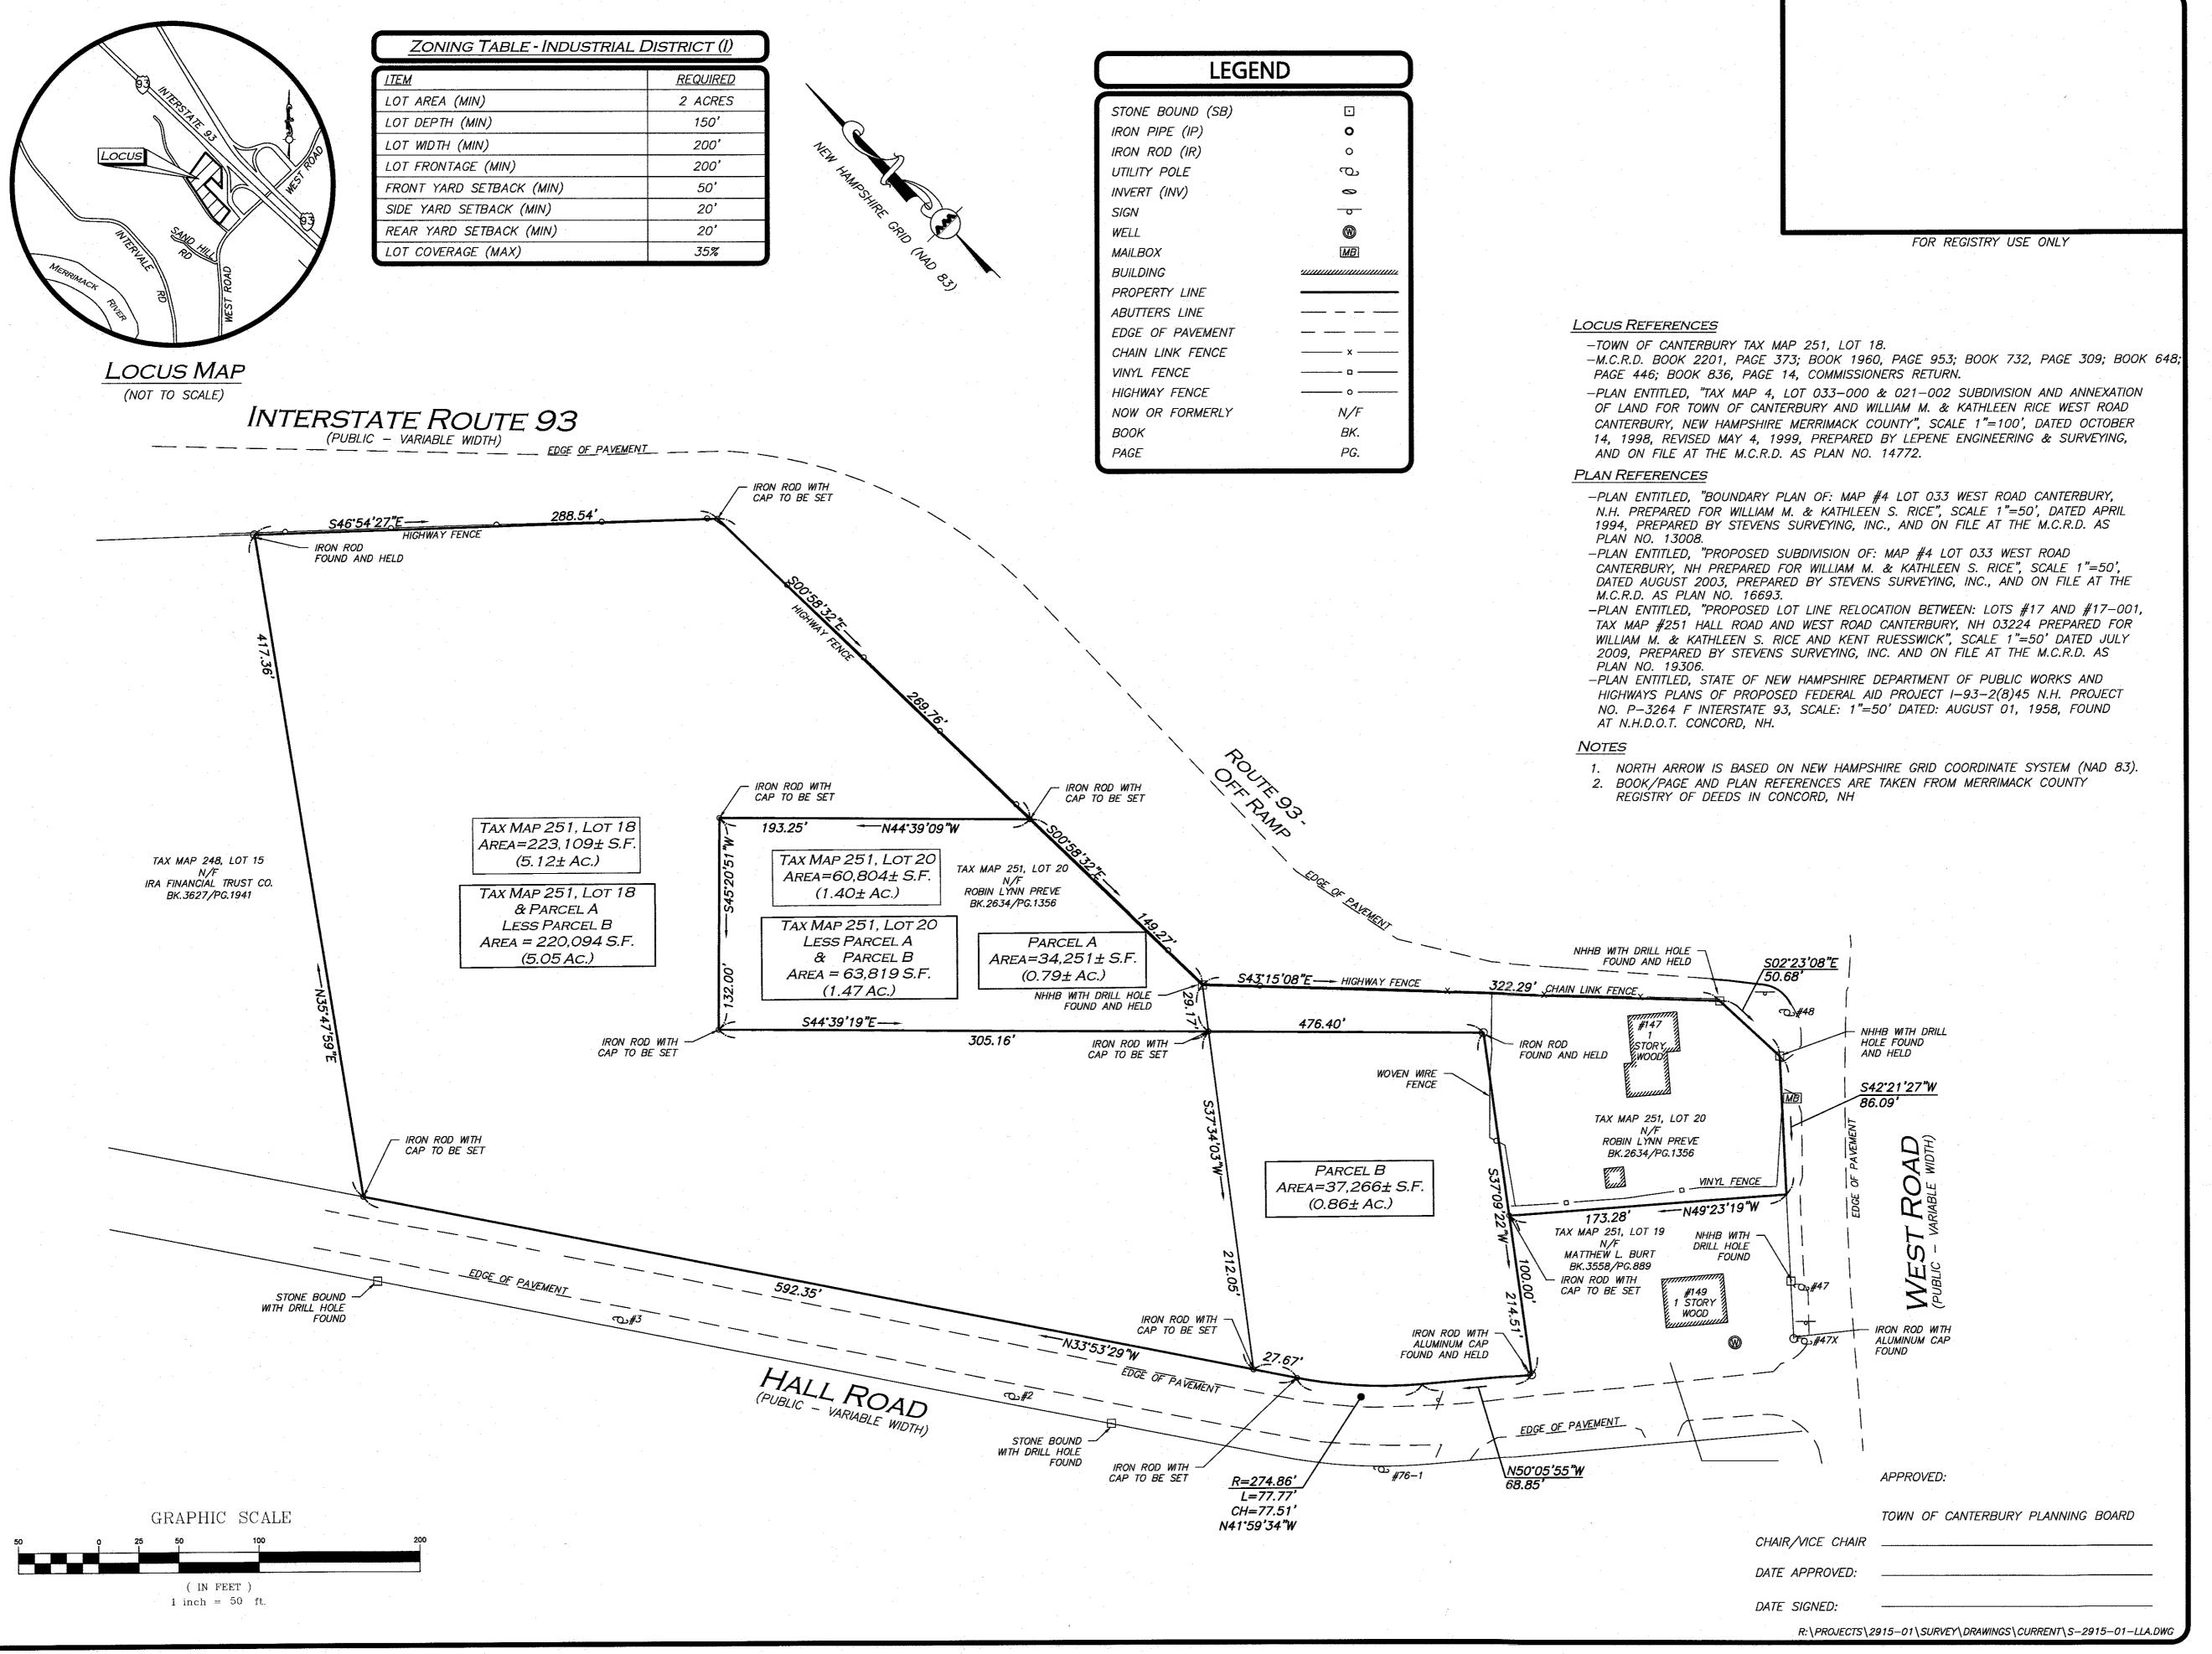

5-13-2021

AMES P. SMITH NH LLS #908

APPLICANT\OWNER: STATION MEADOW, LLC 4 DUNLAP ROAD **BURLINGTON, MA 01803** 

REV DATE DESCRIPTION

PROJECT:

**TAX MAP 251, LOT 18 HALL ROAD** CANTERBURY, NH

PROJECT NO.	2915-01	DATE:	4/23/2
SCALE:	1" = 50'	DWG. NAME: S	-2915-01-LLA
DRAFTED BY:	AJR	CHECKED BY:	JP:
PREPARED BY:			· · · · · ·



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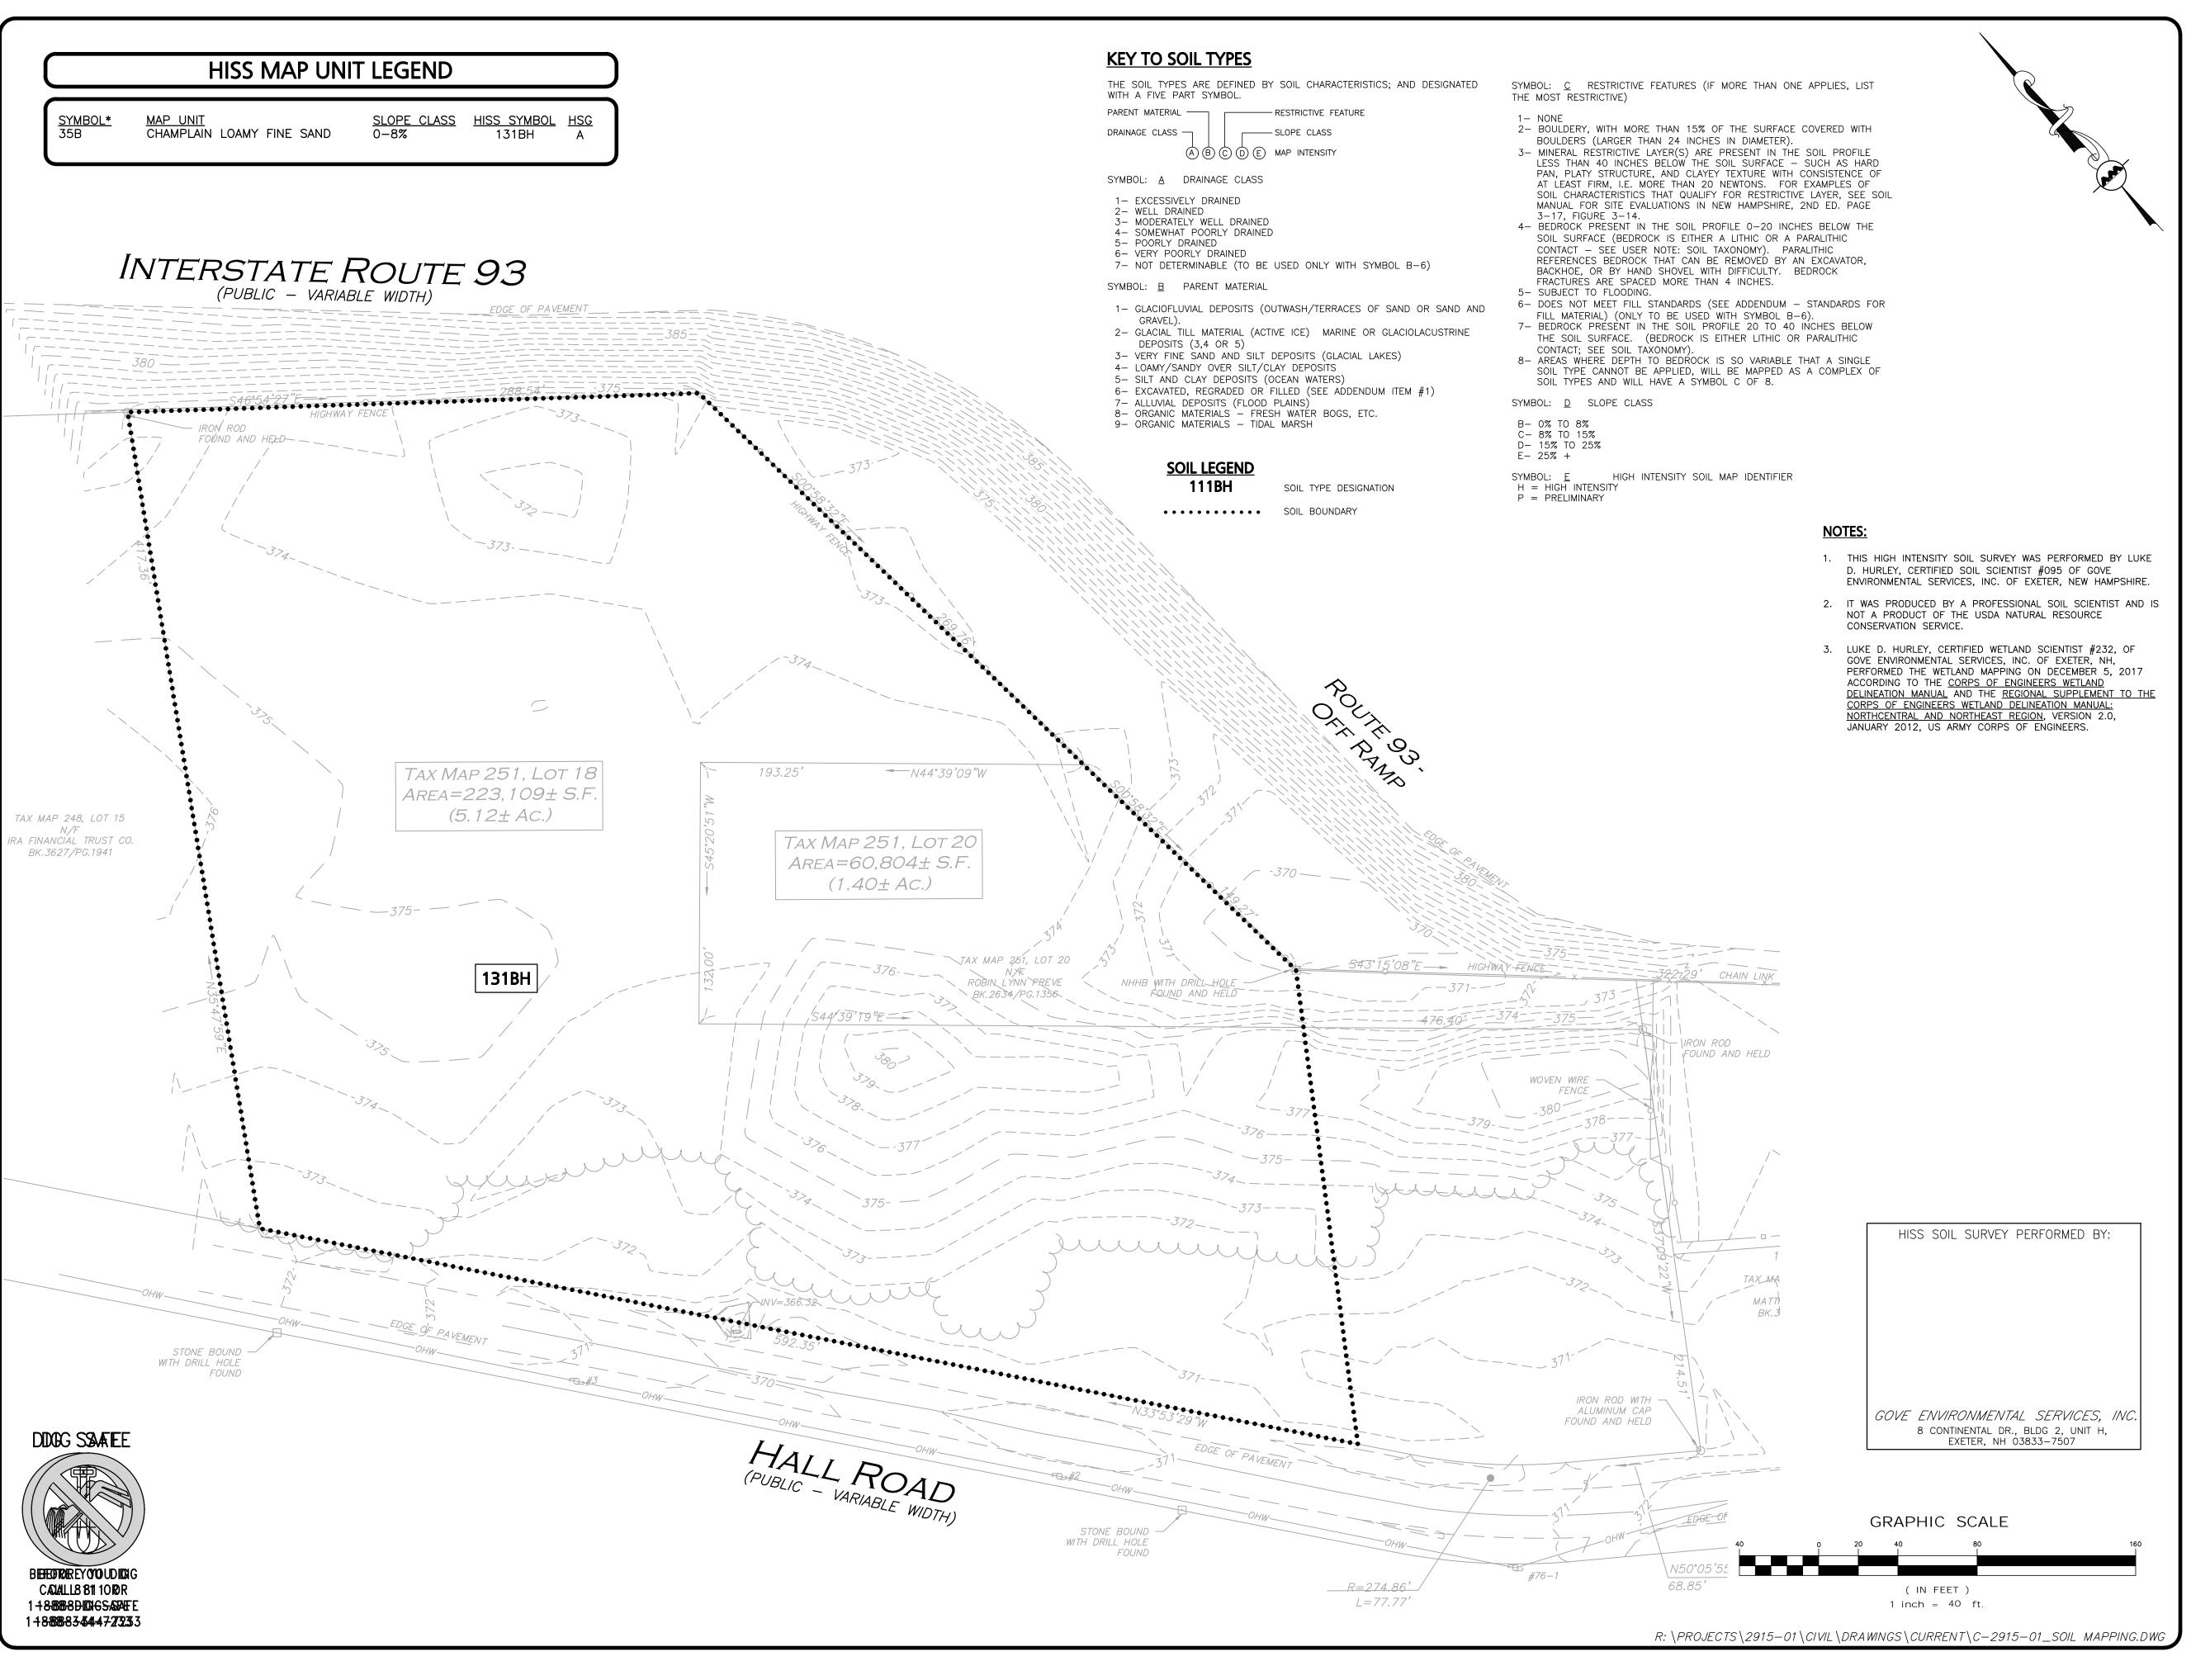
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SHEET No.

V-101

**DRAWING TITLE:** 

LOT LINE **ADJUSTMENT PLAN** 



# **ISSUED FOR REVIEW**

**MAY 17, 2021** 

5-17-2021 | ISSUED FOR REVIEW DATE DESCRIPTION

APPLICANT\OWNER:

STATION MEADOW, LLC 4 DUNLAP ROAD **BURLINGTON, MA 01803** 

PROJECT:

TAX MAP 251, LOT 18 HALL ROAD CANTERBURY, NH

2915-01 DATE: 5/17/2021 PROJECT NO. 1" = 40' DWG. NAME:

ARM | CHECKED BY:



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**DRAWING TITLE:** 

**EXISTING SOILS** MAPPING

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V-102

SHEET No.

# **ZONING SUMMARY TABLE INDUSTRAIL DISTRICT (I)**

ITEM	REQUIRED	PROPOSED
MIN. LOT SIZE	2 ACRES	5.05 ACRES
MIN. LOT DEPTH	150 FEET	228.7 FEET
MIN. LOT WIDTH	200 FEET	288.5 FEET
MIN. LOT FRONTAGE	200 FEET	564.6 FEET
FRONT YARD SETBACK	50 FEET	87.8 FEET
SIDE YARD SETBACK	20 FEET	60.0 FEET
REAR YARD SETBACK	20 FEET	127.9 FEET
MAXIMUM LOT COVERAGE	35%	32.7%

INTERSTATE ROUTE 93

(PUBLIC - VARIABLE WIDTH)


20 FT REAR YARD SETBACK

# **OFF-STREET PARKING SUMMARY TABLE**

USE	CALCULATION	MIN. REQUIRED	PROPOSEI
PHASE 1: WAREHOUSE, STORAGE, WHOLESALE ESTABLISHMENTS 4 EMPLOYEES 6,000 S.F.	1 SPACE PER EMPLOYEE	4	4
PHASE 2: WAREHOUSE, STORAGE, WHOLESALE ESTABLISHMENTS 9 EMPLOYEES 6,500 S.F.	1 SPACE PER EMPLOYEE	9	9
NOTES:	TOTAL	13	13

- TOWN OF CANTERBURY SITE PLAN REVIEW REGULATIONS, V. GENERAL STANDARDS, D. PARKING, LOADING AND PEDESTRIAN SAFETY: 1. SUFFICIENT OFF-STREET PARKING MUST BE PROVIDED FOR THE ANTICIPATED USE TO ACCOMMODATE BOTH EMPLOYEES AND CUSTOMERS SO THAT NO PARKING IS FORCED ONTO PUBLIC STREETS OR NEARBY
- 2. THE APPLICANT HAS PROVIDED PARKING FOR EACH ANTICIPATED EMPLOYEE.
- 3. ADA SPACES REQUIRED:
- (1-25) TOTAL PARKING SPACES PROVIDED REQUIRES 1 ADA SPACE

PROVIDED: 1 ADA SPACES. 1 BEING VAN ACCESSIBLE

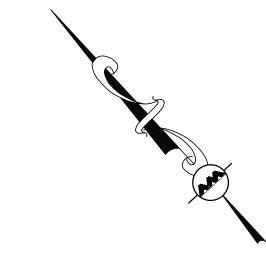

# **LEGEND**

PROP. PROPERTY LINE	
SIGN	<del></del>
BOLLARD	•
BUILDING	
BUILDING ARCHITECTURE	
PARKING STRIPING	< (jr
ROADWAY STRIPING	
HEAVY DUTY CONCRETE	a space of the spa
SIDEWALK	
ADA ACCESSIBLE RAMP	
ADA DET. WARNING SURFACE	***************************************
SETBACK LINE	
PARKING COUNT	10
TREE LINE	~~~
TRANSFORMER	

- PERMITTED BY-RIGHT. OFFICE ESTABLISHMENTS MORE THAN 5,000 SF OF FLOOR AREA MAY BE AUTHORIZED AS A SPECIAL EXCEPTION BY THE
- ACCORDANCE WITH THE TOWN CONSTRUCTION STANDARDS AND DETAILS, LATEST EDITION. THE CONTRACTOR SHALL APPLY FOR AN EXCAVATION PERMIT CONTACT THE TOWN ENGINEERING SERVICES DIVISION PRIOR TO CONSTRUCTION TO APPLY
- PROTECTION DISTRICT SHALL REQUIRE A CONDITIONAL USE PERMIT FOR:
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5-17-2021 | ISSUED FOR REVIEW DATE DESCRIPTION

REV APPLICANT\OWNER:

> STATION MEADOW, LLC 4 DUNLAP ROAD **BURLINGTON, MA 01803**

PROJECT:

TAX MAP 251, LOT 18 HALL ROAD CANTERBURY, NH

2915-01 DATE: 5/17/2021 PROJECT NO. 1" = 40' DWG. NAME: C2915-01 **DESIGNED BY:** ARM | CHECKED BY:



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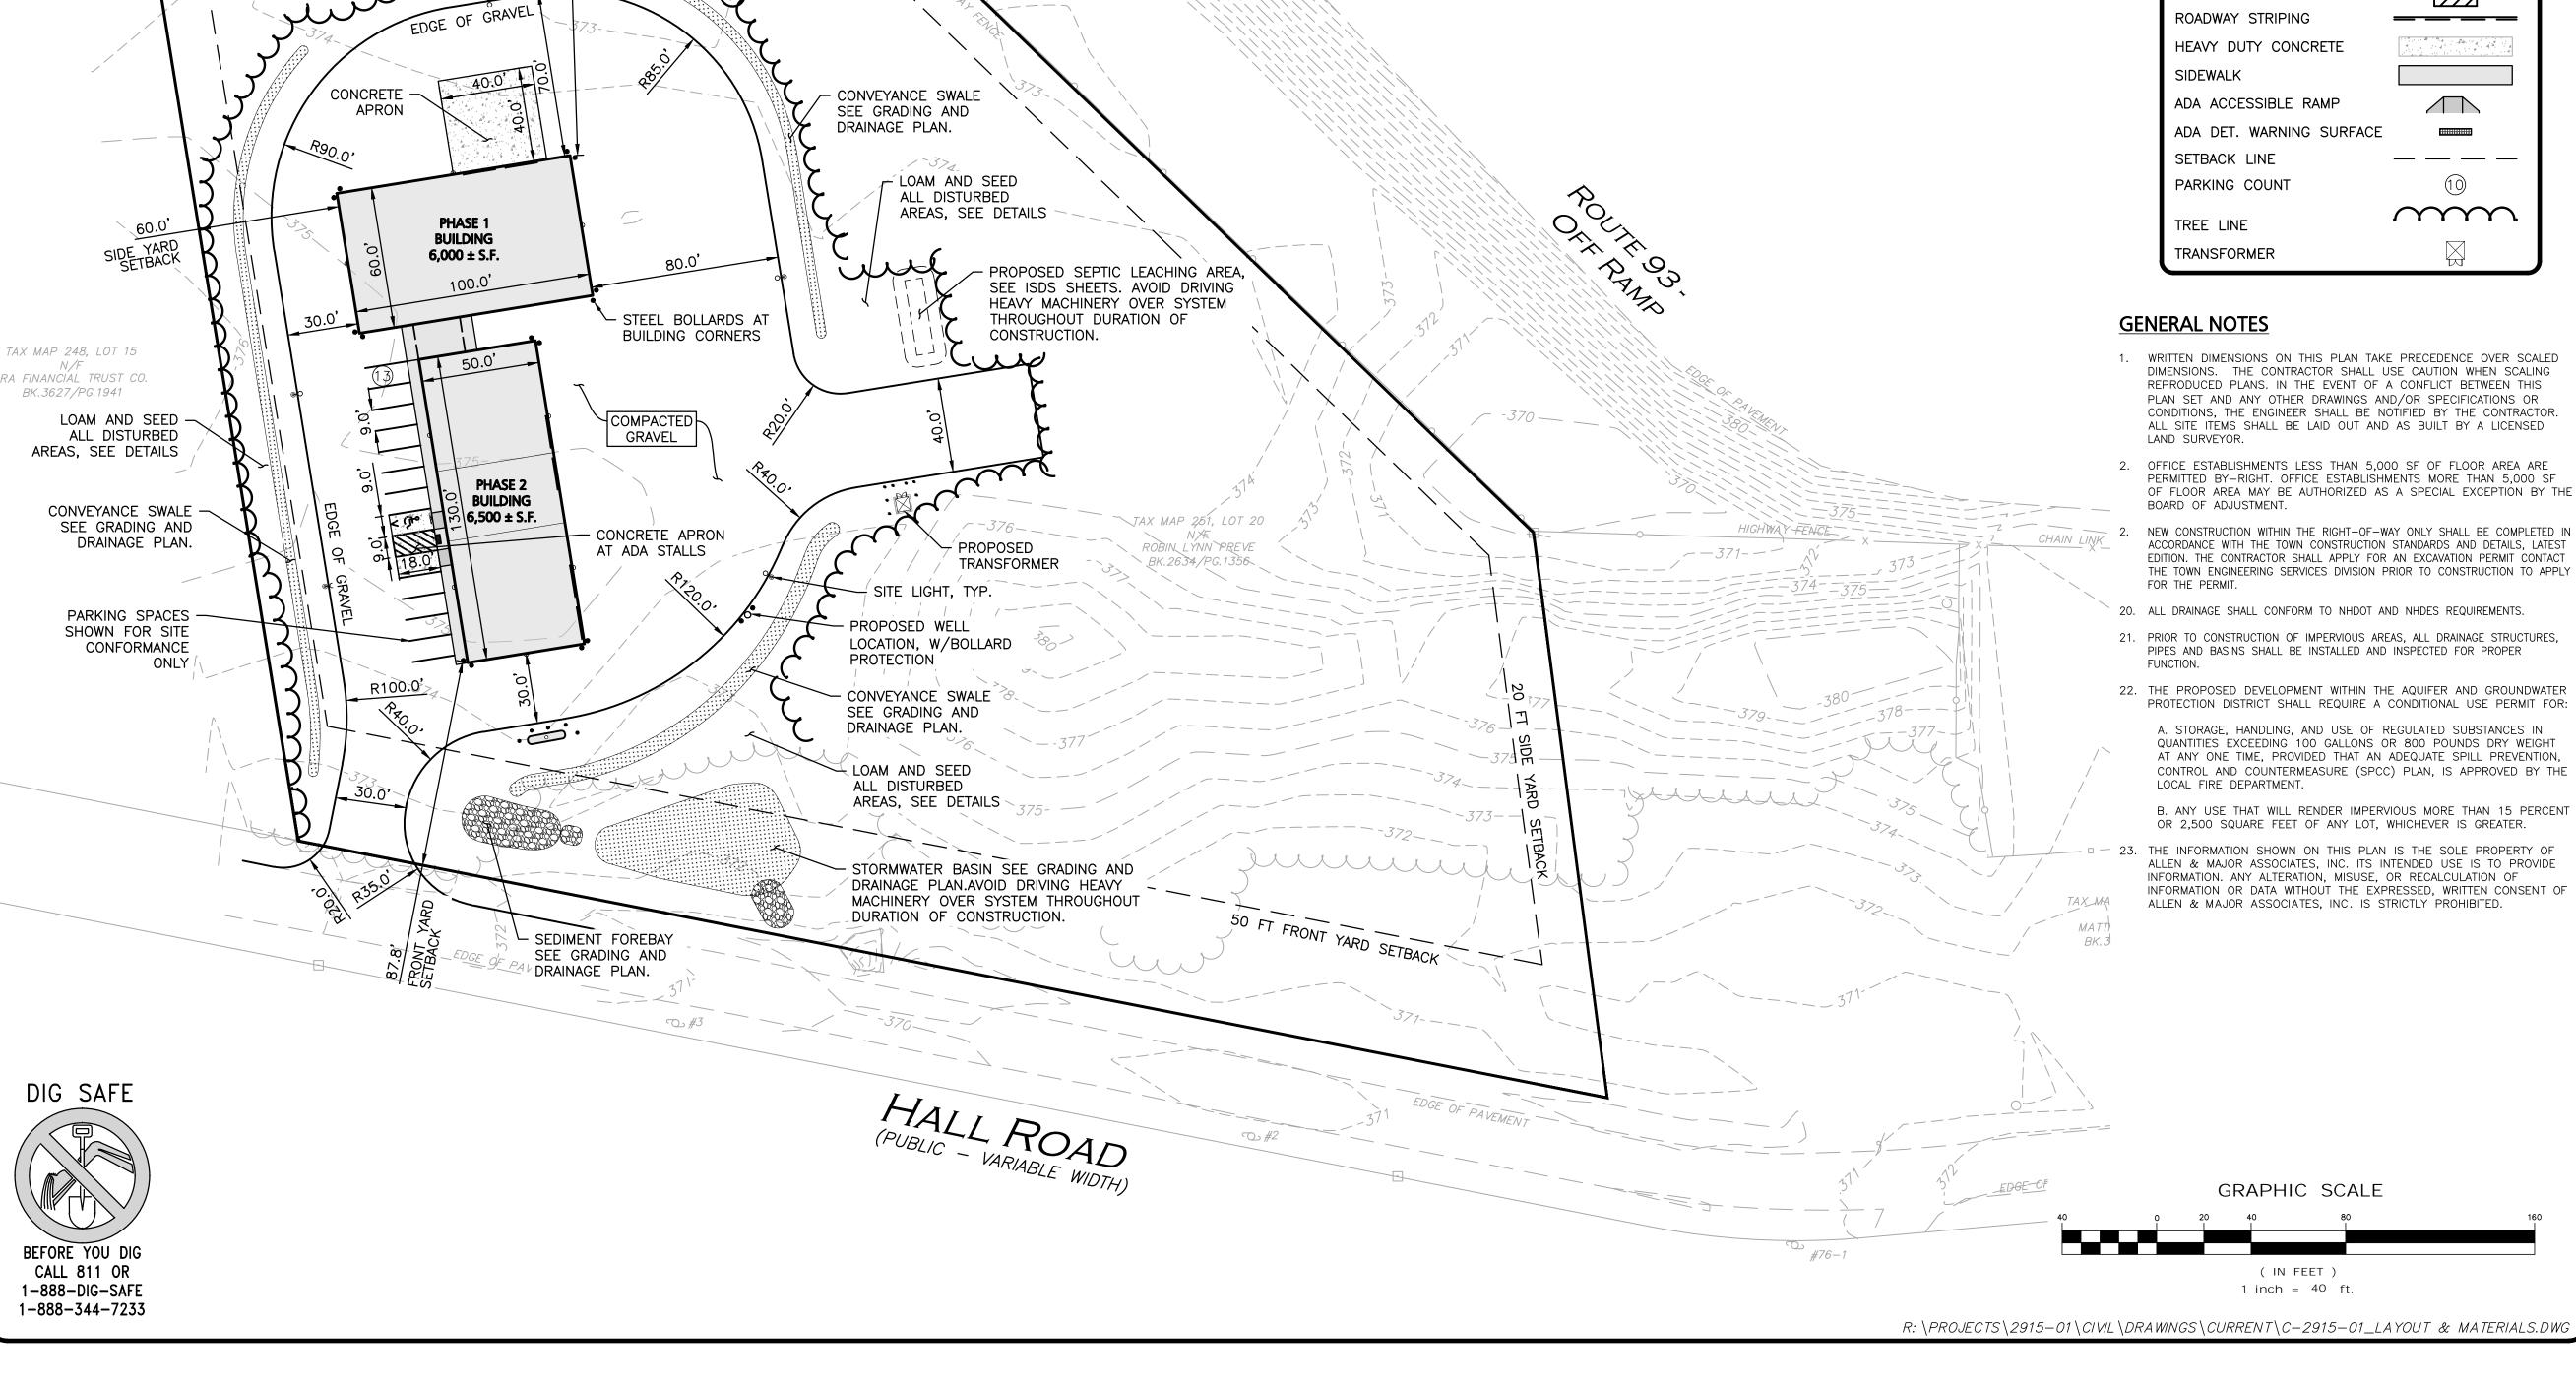
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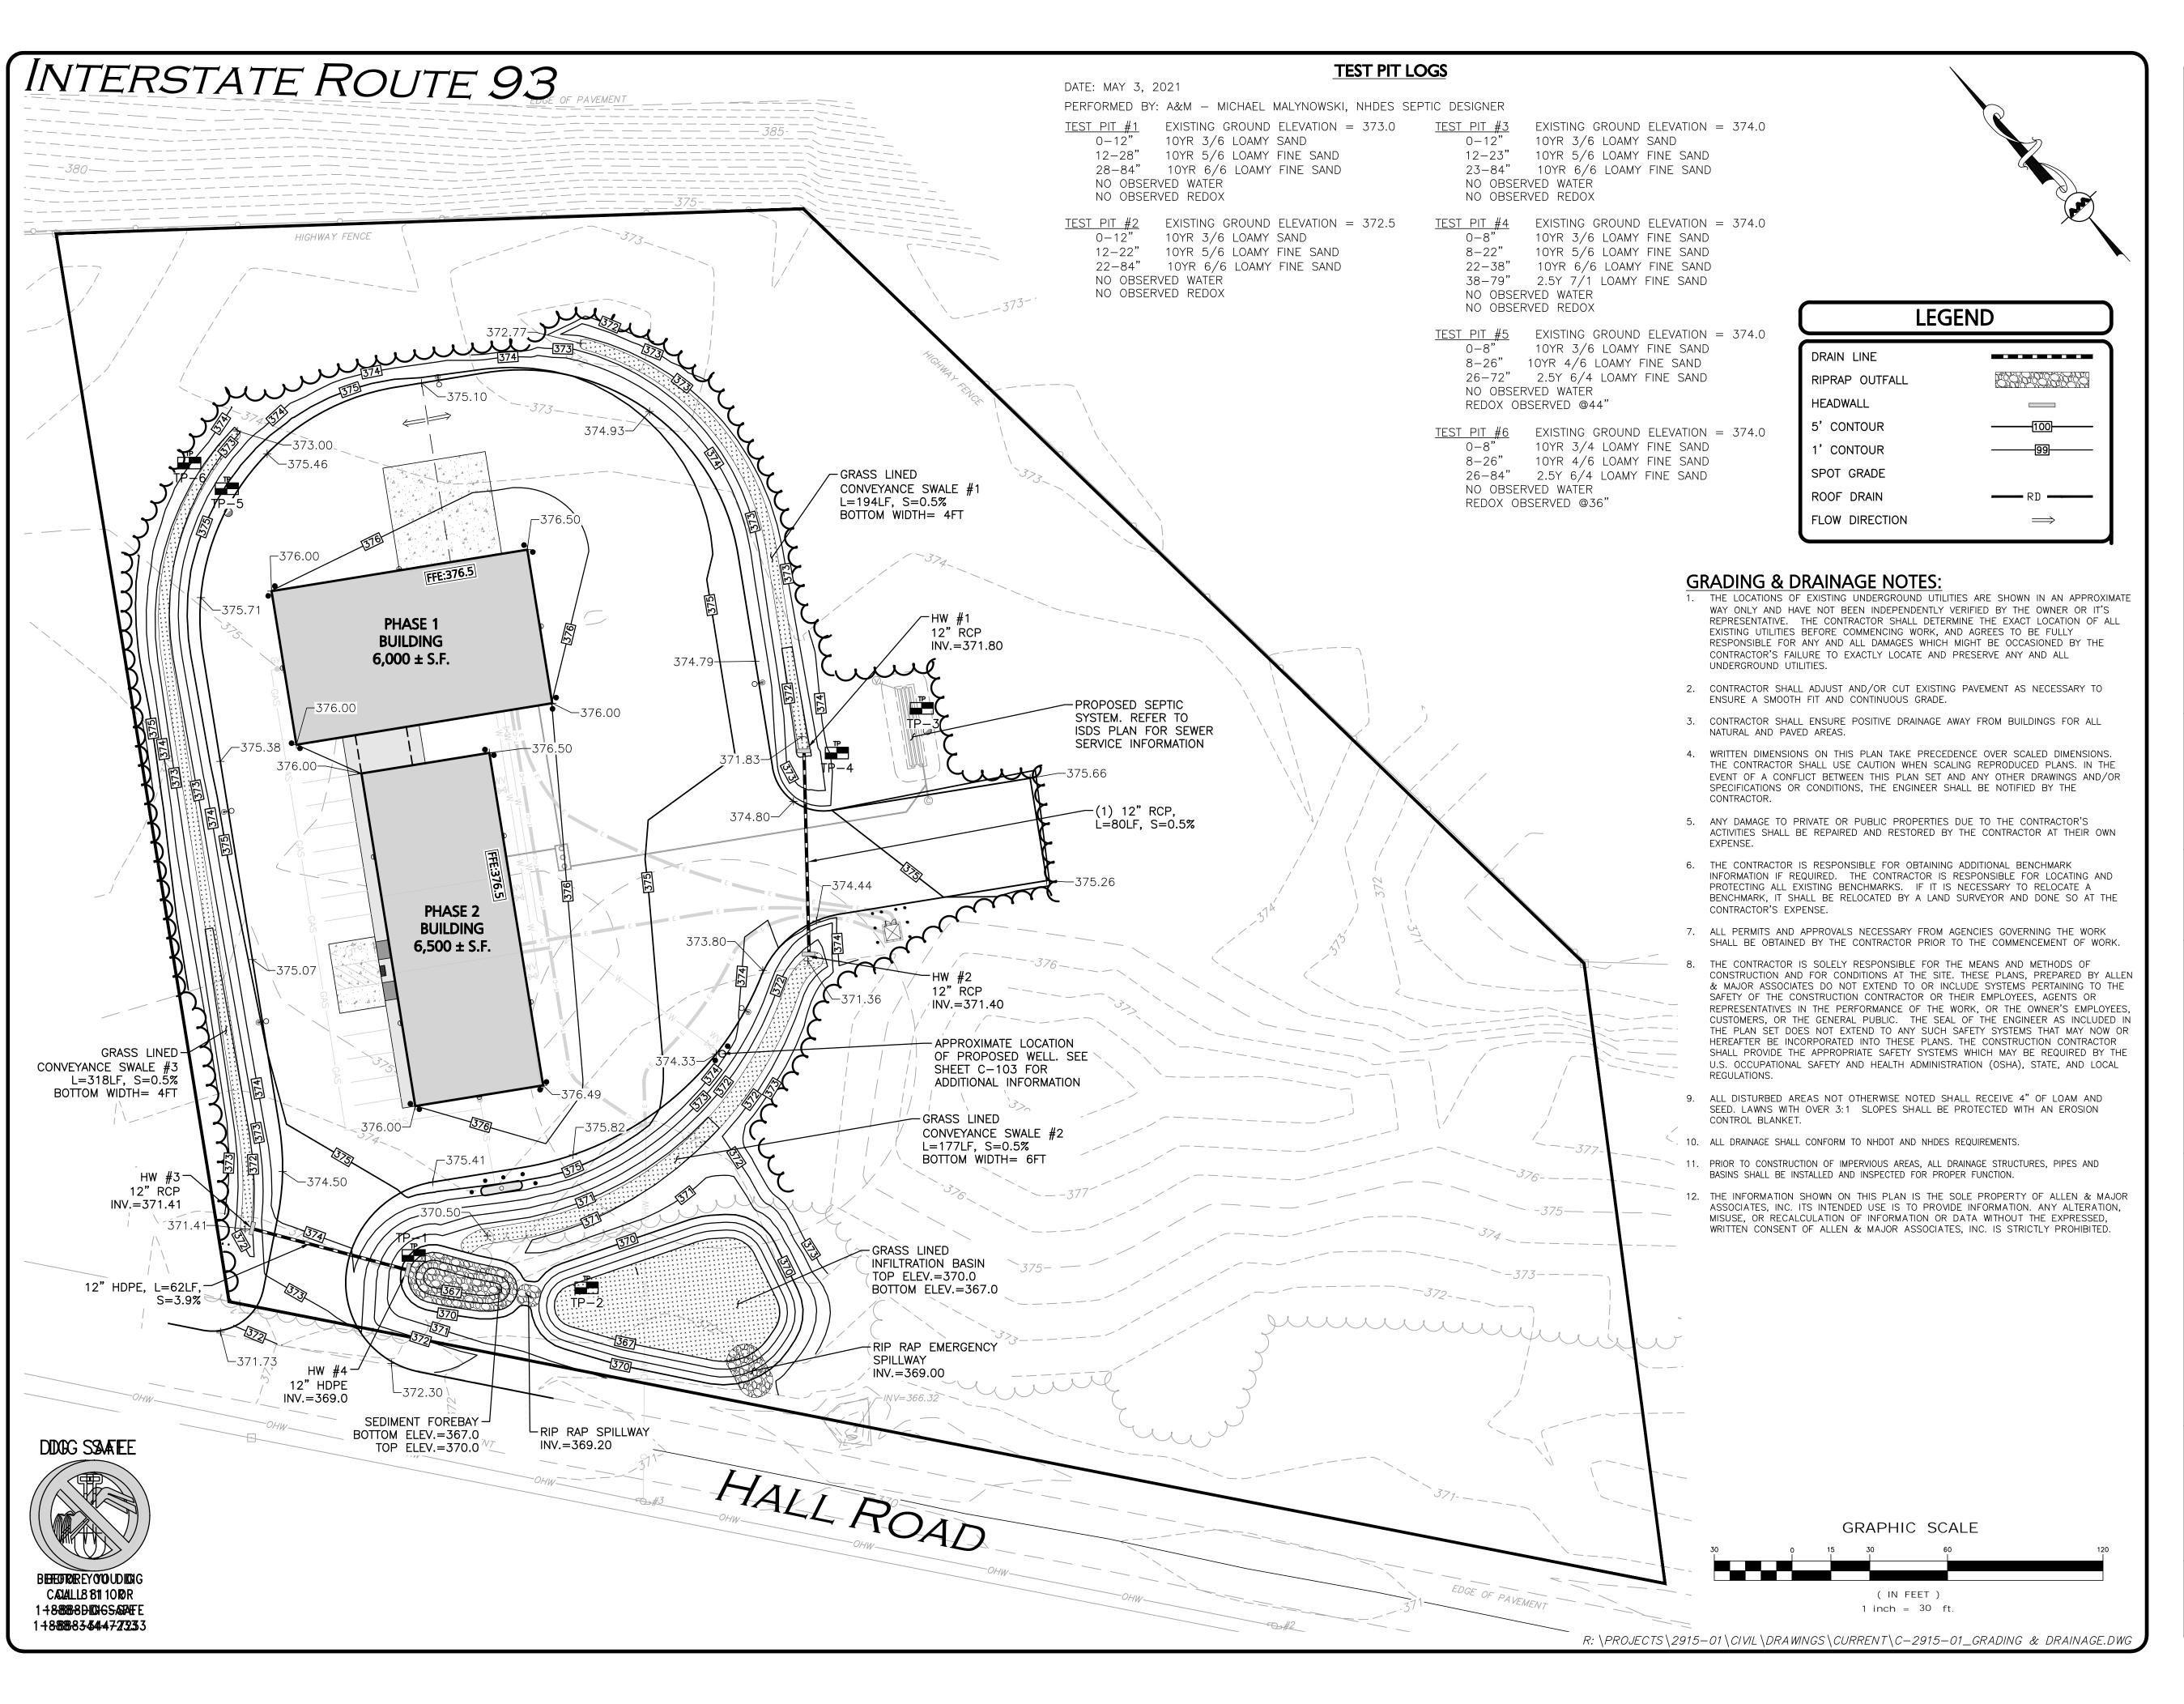
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**DRAWING TITLE:** 

LAYOUT & MATERIALS PLAN | C-100

SHEET No.







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5-17-2021 | ISSUED FOR REVIEW DATE DESCRIPTION

APPLICANT\OWNER:

STATION MEADOW, LLC 4 DUNLAP ROAD BURLINGTON, MA 01803

TAX MAP 251, LOT 18 HALL ROAD CANTERBURY, NH

2915-01 DATE: 5/17/2021 PROJECT NO. 1" = 30' DWG. NAME: **DESIGNED BY:** ARM | CHECKED BY:



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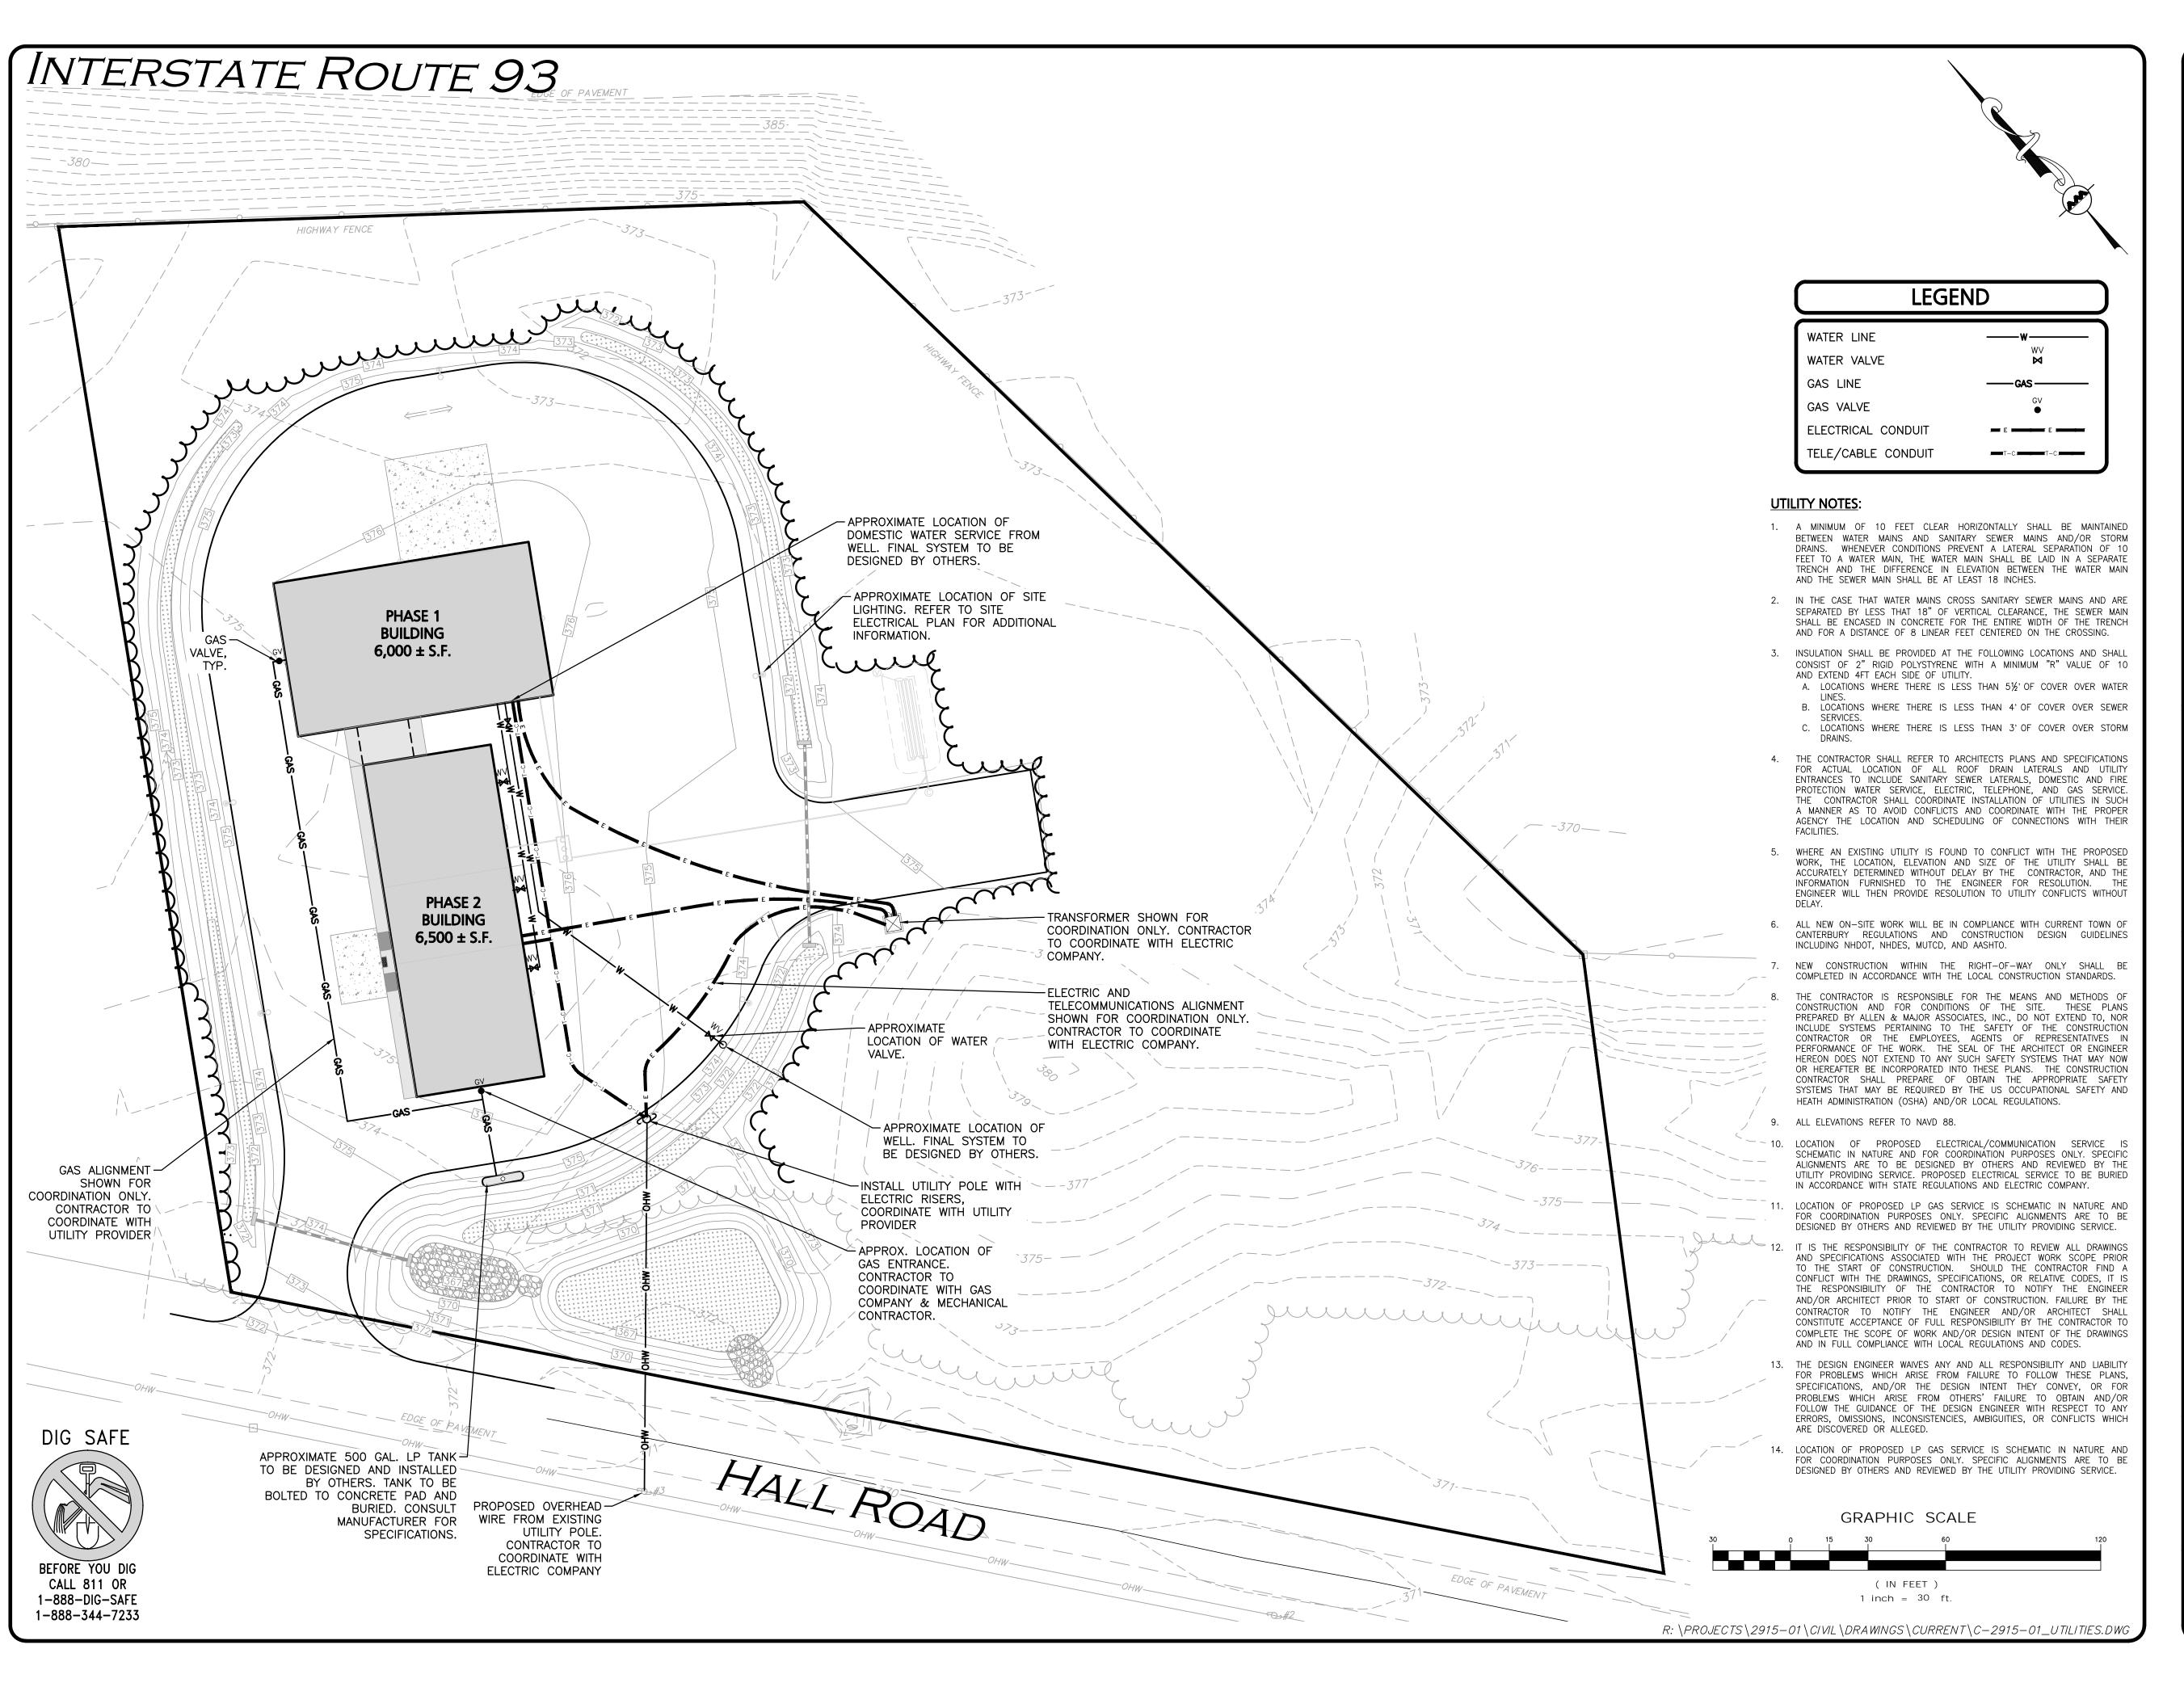
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**DRAWING TITLE:** 

GRADING & DRAINAGE PLAN | C-101





PROFESSIONAL ENGINEER FOR ALLEN & MAJOR ASSOCIATES, INC.

1 5-17-2021 ISSUED FOR REVIEW
REV DATE DESCRIPTION

REV | DATE | DESCRIPTION APPLICANT\OWNER:

STATION MEADOW, LLC 4 DUNLAP ROAD BURLINGTON, MA 01803

PROJECT

TAX MAP 251, LOT 18
HALL ROAD
CANTERBURY, NH

 PROJECT NO.
 2915-01
 DATE:
 5/17/2021

 SCALE:
 1" = \$6"
 DWG. NAME:
 C2915-01

 DESIGNED BY:
 ARM
 CHECKED BY:
 MAM

 PREPARED BY:
 ARM
 CHECKED BY:
 MAM



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DRAWING TITLE:

UTILITIES PLAN

C-102

# DEMOLITION NOTES 1. THE CONTRACTOR SHALL OBTAIN AN EXCAVATION PERMIT FROM THE ENGINEERING SERVICES DIVISION FOR WORK WITHIN THE ROW (IF REQUIRED). 2. THE LOCATIONS OF EXISTING UNDERGROUND UTILITIES ARE SHOWN IN AN APPROXIMATE WAY ONLY AND HAVE NOT BEEN INDEPENDENTLY VERIFIED BY THE OWNER OR IT'S REPRESENTATIVE. THE CONTRACTOR SHALL DETERMINE THE EXACT LOCATION OF ALL EXISTING UTILITIES BEFORE COMMENCING WORK, AND AGREES TO BE FULLY RESPONSIBLE FOR ANY AND ALL DAMAGES WHICH MIGHT BE OCCASIONED BY THE CONTRACTOR'S FAILURE TO EXACTLY LOCATE AND PRESERVE ANY AND ALL UNDERGROUND UTILITIES. 3. GRADING / DEMOLITION OUTSIDE OF THE PROJECT BOUNDARIES REQUIRES A TEMPORARY CONSTRUCTION/GRADING EASEMENT FROM THE LANDOWNER (BY OTHERS). 4. ALTHOUGH CERTAIN ITEMS HAVE BEEN NOTED ON THIS DRAWING FOR DEMOLITION, NO ATTEMPT HAS BEEN MADE TO DELINEATED EACH AND

INTERSTATE ROUTE 93
(PUBLIC - VARIABLE WIDTH)

NOT REFLECT QUANTITY.

EVERY ITEM THAT REQUIRES DEMOLITION FOR THE COMPLETION OF THE PROJECT. THE CONTRACTOR WILL BE RESPONSIBLE FOR ALL

NECESSARY DEMOLITION WORK TO COMPLETE THE PROJECT. ALLEN & MAJOR ASSOCIATES, INC. IS NOT RESPONSIBLE FOR SITE DEMOLITION

ITEMS NOT SHOWN ON THE SURVEY, OR SPECIFICALLY NOTED. THE DEMOLITION NOTES AND ARROWS ON THIS PLAN ARE TYPICAL AND DO


# THE SITE IS NOT LOCATED IN THE 100 YEAR FLOOD ZONE. THE INFORMATION SHOWN ON THIS PLAN IS THE SOLE PROPERTY OF ALLEN & MAJOR ASSOCIATES, INC. ITS INTENDED USE IS TO PROVIDE INFORMATION. ANY ALTERATION, MISUSE, OR RECALCULATION OF INFORMATION OR DATA WITHOUT THE EXPRESSED, WRITTEN CONSENT OF ALLEN & MAJOR ASSOCIATES, INC. IS STRICTLY PROHIBITED.

- 4. THE CONTRACTOR IS RESPONSIBLE FOR THE MEANS AND METHODS OF CONSTRUCTION AND FOR CONDITIONS OF THE SITE. THESE PLANS PREPARED BY ALLEN & MAJOR ASSOCIATES, INC., DO NOT EXTEND TO, NOR INCLUDE SYSTEMS PERTAINING TO THE SAFETY OF THE CONSTRUCTION CONTRACTOR OR THE EMPLOYEES, AGENTS OF REPRESENTATIVES IN PERFORMANCE OF THE WORK. THE SEAL OF THE ARCHITECT OR ENGINEER HEREON DOES NOT EXTEND TO ANY SUCH SAFETY SYSTEMS THAT MAY NOW OR HEREAFTER BE INCORPORATED INTO THESE PLANS. THE CONSTRUCTION CONTRACTOR SHALL PREPARE OF OBTAIN THE APPROPRIATE SAFETY SYSTEMS THAT MAY BE REQUIRED BY THE US OCCUPATIONAL SAFETY AND HEATH ADMINISTRATION (OSHA) AND/OR LOCAL REGULATIONS.
- 5. FOR ANY NEW SIGNAGE, A SITE SIGNAGE PACKAGE SHALL BE COORDINATED WITH THE DEPARTMENT OF BUILDING SAFETY FOR ORDINANCE AND/OR APPLICATION REQUIREMENTS.
- 6. ALL NEW WORK WILL BE IN COMPLIANCE WITH CURRENT SITE PLAN AND ZONING REGULATIONS.

**GENERAL NOTES** 

1. SEE SHEET V-100 FOR EXISTING CONDITIONS.

# TUBULAR BARRIER STABILIZED ENTRANCE STOCKPILE/STAGING AREA TEMPORARY CONSTRUCTION FENCE TUBULAR BARRIER TEMPORARY TE

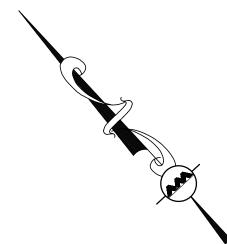

# **EROSION CONTROL AND SEDIMENT CONTROL NOTES:**

- 1. AS CONSTRUCTION DISTURBANCE IS GREATER THAN 1 ACRE, A NATIONAL POLLUTANT DISCHARGE ELIMINATION SYSTEM (NPDES) CONSTRUCTION GENERAL PERMIT NOI, IS REQUIRED. A STORM WATER POLLUTION PREVENTION PLAN (SWPPP) SHALL BE SUBMITTED FOR REVIEW AND APPROVAL PRIOR TO MOBILIZATION.
- 2. CONTRACT ADMINISTRATOR AND CONTRACTOR ARE RESPONSIBLE FOR COMPLIANCE WITH THE CONSTRUCTION GENERAL PERMIT NOI. COPIES OF ALL SWPPP REPORTS SHALL BE KEPT ONSITE AND MADE AVAILABLE FOR INSPECTION BY LOCAL, STATE, AND FEDERAL AGENCIES.
- 3. SILT CONTROL SHALL BE INSTALLED PRIOR TO DISTURBANCE AND SHALL BE ADEQUATE TO MAINTAIN SEDIMENT ON SITE. ANY MODIFICATIONS TO SILT CONTROLS SHOWN ON THE APPROVED PLANS AS A RESULT OF ACTUAL FIELD CONDITIONS OR CONSTRUCTION PRACTICES SHALL BE INSTALLED IN ACCORDANCE WITH "NEW HAMPSHIRE STORMWATER MANUAL VOLUMES 1, 2, AND 3" DATED DECEMBER 2008.. ANY SUCH MODIFICATIONS SHALL BE INSTALLED AS APPROVED BY THE ENGINEER.
- 4. THE CONTRACTOR SHALL CONDUCT INSPECTIONS WITHIN 24 HOURS OF RAINFALL EVENTS GREATER THAN 0.25" IN ADDITION TO INSPECTIONS EVERY 7 DAYS (WEEKLY) & MAINTAIN A LOG IN ACCORDANCE WITH EPA, AND CONTRACT ADMINISTRATOR.
- 5. AREAS OF EXPOSED SOIL UNDERGOING CONSTRUCTION THAT WILL NOT BE COVERED AND OR FINISHED GRADED WITHIN 7 DAYS OF EXPOSURE SHALL BE ANCHORED WITH TEMPORARY EROSION CONTROL MEASURES.
- 6. IF DISTURBED AREAS DO NOT RECEIVE FINAL SEEDING BY SEPTEMBER 15 OF THE CONSTRUCTION YEAR, THEN ALL DISTURBED AREAS SHALL BE SEEDED WITH A WINTER COVER CROP AT THE RATE OF 3 LBS PER 1,000 SQUARE FEET. WINTER SEEDING SHALL BE COVERED WITH EROSION CONTROL MESH (MULCH AND NETTING).
- 7. SOIL AND FILL STOCKPILES EXPECTED TO REMAIN IN PLACE FOR LESS THAN 90 DAYS SHALL BE COVERED WITH STRAW AND MULCH (AT 100LBS/1,000 SF), OR WITH AN ANCHORED TARP WITHIN 7 DAYS OR PRIOR TO ANY RAINFALL. SOIL AND FILL STOCKPILES EXPECTED TO REMAIN IN PLACE FOR 90 DAYS OR MORE SHALL BE SEEDED WITH WINTER RYE (FOR FALL SEEDING AT 3LB/1,000 SF) OR OATS (FOR SUMMER SEEDING AT 2LB/1,000 SF) AND THEN COVERED WITH STRAW MULCH (AT 100LB/1,000 SF) OR AN ANCHORED TARP WITHIN 7 DAYS OR PRIOR TO ANY RAINFALL. LOAM SHALL BE STOCKPILED AT LOCATIONS DESIGNATED BY THE CONTRACT ADMINISTRATOR AND ENGINEER.
- 8. ALL TUBULAR BARRIERS, SILT SACKS, AND FILTER FABRICS SHALL BE INSTALLED ACCORDING TO THIS PLAN. THESE SHALL BE MAINTAINED DURING CONSTRUCTION TO REMOVE SEDIMENT FROM RUNOFF WATER. ALL THE EROSION CONTROL MEASURES SHALL BE INSPECTED AFTER ANY RAINFALL OR RUNOFF EVENT, MAINTAINED AND CLEANED UNTIL ALL AREAS HAVE AT LEAST 85-90% VIGOROUS PERENNIAL COVER OF GRASSES.
- 9. A WATERING TRUCK WILL BE USED TO PERIODICALLY SPRINKLE CONSTRUCTION AREAS IN ORDER TO KEEP THE LEVEL OF DUST TO A MINIMUM DURING THE DRY MONTHS AND AS REQUIRED.
- 10. THE CONTRACTOR SHALL USE EXTREME CAUTION TO AVOID ALLOWING SEDIMENTS TO ENTER THE STORM DRAIN SYSTEM DURING CONSTRUCTION.

  CATCH BASIN INLETS SHALL ALSO BE PROTECTED DURING CONSTRUCTION BY THE USE OF STRAW BALE BARRIERS AROUND EACH INLET. SILT SACKS SHALL BE INSTALLED IN ALL EXISTING AND INSTALLED BASINS. INLET PROTECTION MAY BE REMOVED ONLY AFTER FINISHED AREAS ARE PAVED AND THE VEGETATED SLOPES ARE ESTABLISHED WITH AT LEAST 85-90% OF VIGOROUS PERENNIAL GROWTH.
- 11. REVEGETATION MEASURES SHALL COMMENCE IMMEDIATELY UPON THE COMPLETION OF CONSTRUCTION. FOLLOWING SEED BED PREPARATION ALL AREAS NOT NOTED TO RECEIVE COVER SHALL BE LOAM AND SEEDED. AREAS SEEDED BETWEEN MAY 15 TO AUGUST 15TH SHALL BE COVERED WITH STRAW MULCH. VEGETATED GROWTH COVERING AT LEAST 85% OF THE DISTURBED AREA SHALL BE ACHIEVED PRIOR TO OCTOBER 15TH. STRAW MULCHES SHALL BE ANCHORED WITH MULCH NETTING OR TACKIFIER SO THAT THEY ARE NOT BLOWN AWAY BY WIND OR WASHED AWAY BY FLOWING WATER. STRAW MULCH SHALL BE APPLIED AT A RATE OF 1.5 TO 2 TONS PER ACRE OR 70 TO 90 LBS. PER 1,000 S.F.
- 12. IN LIEU OF SOIL TESTS, SOIL AMENDMENTS FOR TEMPORARY SEEDED AREAS MAY BE APPLIED AS FOLLOWS:
- 10-10-10 FERTILIZER (N-P205-K20 OR EQUAL)- APPLICATION RATE= 25 LBS/1,000 S.F.
   GROUND LIMESTONE (85% OF TOTAL CARBONATES. LIMESTONE SHALL BE GROUND TO SUCH FINENESS THAT 50% WILL PASS A 100 MESH
- SIEVE AND 90% WILL PASS THROUGH A 20 MESH SIEVE. APPLICATION RATE = 100 LB/1,000 S.F.

   WHEN FERTILIZER IS APPLIED WITHIN 100' OF ANY RIVER, STREAM, POND, OR LAKE IT SHALL BE RESTRICTED TO A LOW PHOSPHATE, SLOW
- 13. LOAM WILL BE SPREAD OVER DISTURBED AREAS AND SMOOTHED TO A UNIFORM SURFACE PER SPECIFICATIONS. LOAM SHALL BE FREE OF SOIL, CLAY LUMPS, STONES AND OTHER OBJECTS OVER 1 INCH IN DIAMETER, AND WITHOUT WEEDS, ROOTS OR OTHER DELETERIOUS MATERIAL AND MEET THE LOAM SPECIFICATION DETAIL.
- 14. EROSION CONTROL MESH SHALL BE APPLIED WHERE SLOPES EXCEED 3:1.

IN THE EVEN OF ANY FAILURES UNTIL VEGETATION IS ADEQUATELY ESTABLISHED.


RELEASE NITROGEN FERTILIZER.

- 15. AT THE CONTRACT ADMINISTRATOR'S DISCRETION ADDITIONAL EROSION CONTROL MEASURES MAY BE REQUIRED TO MAINTAIN STABILITY OF EARTHWORKS AND FINISHED GRADED AREAS. THE CONTRACTOR, AT HIS EXPENSE, WILL BE RESPONSIBLE FOR PROVIDING AND INSTALLING ANY ADDITIONAL MEASURES AS SPECIFIED BY THE CONTRACT ADMINISTRATOR. THIS INCLUDES BUT IS NOT LIMITED TO REQUESTS BY EPA, THE ENGINEER AND THE MUNICIPALITY, AS AUTHORIZED BY THE CONTRACT ADMINISTRATOR.
- 16. IF ANY EVIDENCE OF SEDIMENTATION IS OBSERVED IN THE INLETS, THE CONTRACTOR SHALL, AT HIS OWN EXPENSE, PROVIDE A PLAN TO THE ENGINEER TO REMOVE ANY ACCUMULATED SEDIMENT IN THESE AREAS. THE CONTRACTOR SHALL ALSO IMMEDIATELY PROVIDE ADDITIONAL ON SITE EROSION AND SEDIMENTATION CONTROL MEASURES TO PREVENT FURTHER DEGRADATION OF THE AREA.
- 17. FOLLOWING THE TEMPORARY OR FINAL SEEDINGS, THE CONTRACTOR SHALL INSPECT THE WORK AREA BIMONTHLY TO ENSURE THE AREAS HAVE A MINIMUM OF 85–90% VEGETATED VIGOROUS GROWTH. RESEEDING SHALL BE CARRIED OUT BY THE CONTRACTOR WITH FOLLOW UP INSPECTIONS
- 18. THE AREA OR AREAS OF ENTRANCE AND EXIT TO AND FROM THE SITE SHALL BE MAINTAINED IN A CONDITION WHICH WILL PREVENT TRACKING OR FLOWING OF SEDIMENT ONTO PUBLIC RIGHT-OF-WAY MUST BE REMOVED IMMEDIATELY.
- 19. THE CONTRACTOR SHALL INSTALL ADDITIONAL SEDIMENT CONTROL MEASURES AS DETERMINED NECESSARY AND AT THE REQUEST OF THE TOWN'S SITE INSPECTOR OR REPRESENTATIVE.
- 20. THE CONTRACTOR SHALL STORE ADDITIONAL SEDIMENT CONTROLS ON—SITE TO BE USED FOR REPLACING DAMAGED SEDIMENT CONTROLS OR INSTALLED AS DIRECTED BY THE TOWN'S INSPECTOR TO PROVIDE ADDITIONAL PROTECTIVE MEASURES.

# SPILL PREVENTION AND RESPONSE NOTES:

SOURCES OF POTENTIAL SPILL HAZARDS INCLUDE VEHICLE FLUIDS, LIQUID FUELS, PESTICIDES, PAINTS, SOLVENTS, AND LIQUID CLEANING PRODUCTS. THE MAJORITY OF THE SPILL HAZARDS WOULD LIKELY OCCUR WITHIN THE BUILDING AND WOULD NOT ENTER THE STORMWATER DRAINAGE SYSTEM. HOWEVER, THERE ARE SPILL HAZARDS FROM VEHICLE FLUIDS OR LIQUID FUELS LOCATED OUTSIDE OF THE BUILDINGS. THESE EXTERIOR SPILL HAZARDS HAVE THE POTENTIAL TO ENTER THE STORMWATER DRAINAGE SYSTEM AND ARE TO BE ADDRESSED AS FOLLOWS:

- SPILL HAZARDS OF PESTICIDES, PAINTS, AND SOLVENTS SHALL BE REMEDIATED USING THE MANUFACTURERS' RECOMMENDED SPILL CLEANUP PROTOCOL.
- 2. VEHICLE FLUIDS AND LIQUID FUEL SPILL SHALL BE REMEDIATED ACCORDING TO THE LOCAL AND STATE REGULATIONS GOVERNING FUEL SPILLS.
- 3. THE CONTRACT ADMINISTRATOR SHALL ENSURE THAT THE GENERAL CONTRACTOR HAS THE FOLLOWING EQUIPMENT AND MATERIALS ON HAND TO ADDRESS A SPILL CLEAN-UP: BROOMS, DUST PANS, MOPS, RAGS, GLOVES, ABSORPTIVE MATERIAL, SAND, SAWDUST, PLASTIC AND METAL TRASH CONTAINERS.
- 4. ALL SPILLS SHALL BE CLEANED UP IMMEDIATELY AFTER DISCOVERY.
- 5. SPILLS OF TOXIC OR HAZARDOUS MATERIAL SHALL BE REPORTED, REGARDLESS OF SIZE, TO THE NEW HAMPSHIRE DEPARTMENT OF ENVIRONMENTAL SERVICES AT (603) 271-3440 AND THE CITY OF CONCORD FIRE DEPARTMENT AT 603-225-8650.
- 6. SHOULD A SPILL OCCUR, THE POLLUTION PREVENTION PLAN WILL BE ADJUSTED TO INCLUDE MEASURES TO PREVENT ANOTHER SPILL OF A SIMILAR NATURE. A DESCRIPTION OF THE SPILL, ALONG WITH THE CAUSES AND CLEANUP MEASURES WILL BE INCLUDED IN THE UPDATED POLLUTION PREVENTION PLAN.

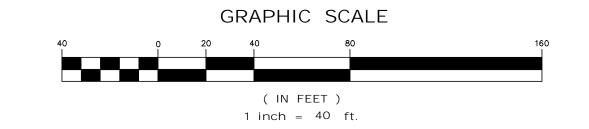

R: \PROJECTS\2915-01\CIVIL\DRAWINGS\CURRENT\C-2915-01\_EROSION CONTROL.DWG



PROFESSIONAL ENGINEER FOR ALLEN & MAJOR ASSOCIATES, INC.

1	5-17-2021	ISSUED FOR REVIEW
REV	DATE	DESCRIPTION

APPLICANT\OWNER:

STATION MEADOW, LLC 4 DUNLAP ROAD BURLINGTON, MA 01803

PROJECT:

TAX MAP 251, LOT 18
HALL ROAD
CANTERBURY, NH

 PROJECT NO.
 2915-01
 DATE:
 5/17/2021

 SCALE:
 1" = 40'
 DWG. NAME:
 C2915-01

 DESIGNED BY:
 ARM
 CHECKED BY:
 MAM

 PREPARED BY:
 ARM
 CHECKED BY:
 MAM



ivil engineering • land surveying environments
consulting • landscape architecture
www.allenmajor.com
400 HARVEY ROAD

MANCHESTER, NH 03103 TEL: (603) 627-5500 FAX: (603) 627-5501

VOBURN, MA ♦ LAKEVILLE, MA ♦ MANCHESTER, NH


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DRAWING TITLE:

EROSION CONTROL PLAN

CONTROL PLAN C-103

SHEET No.

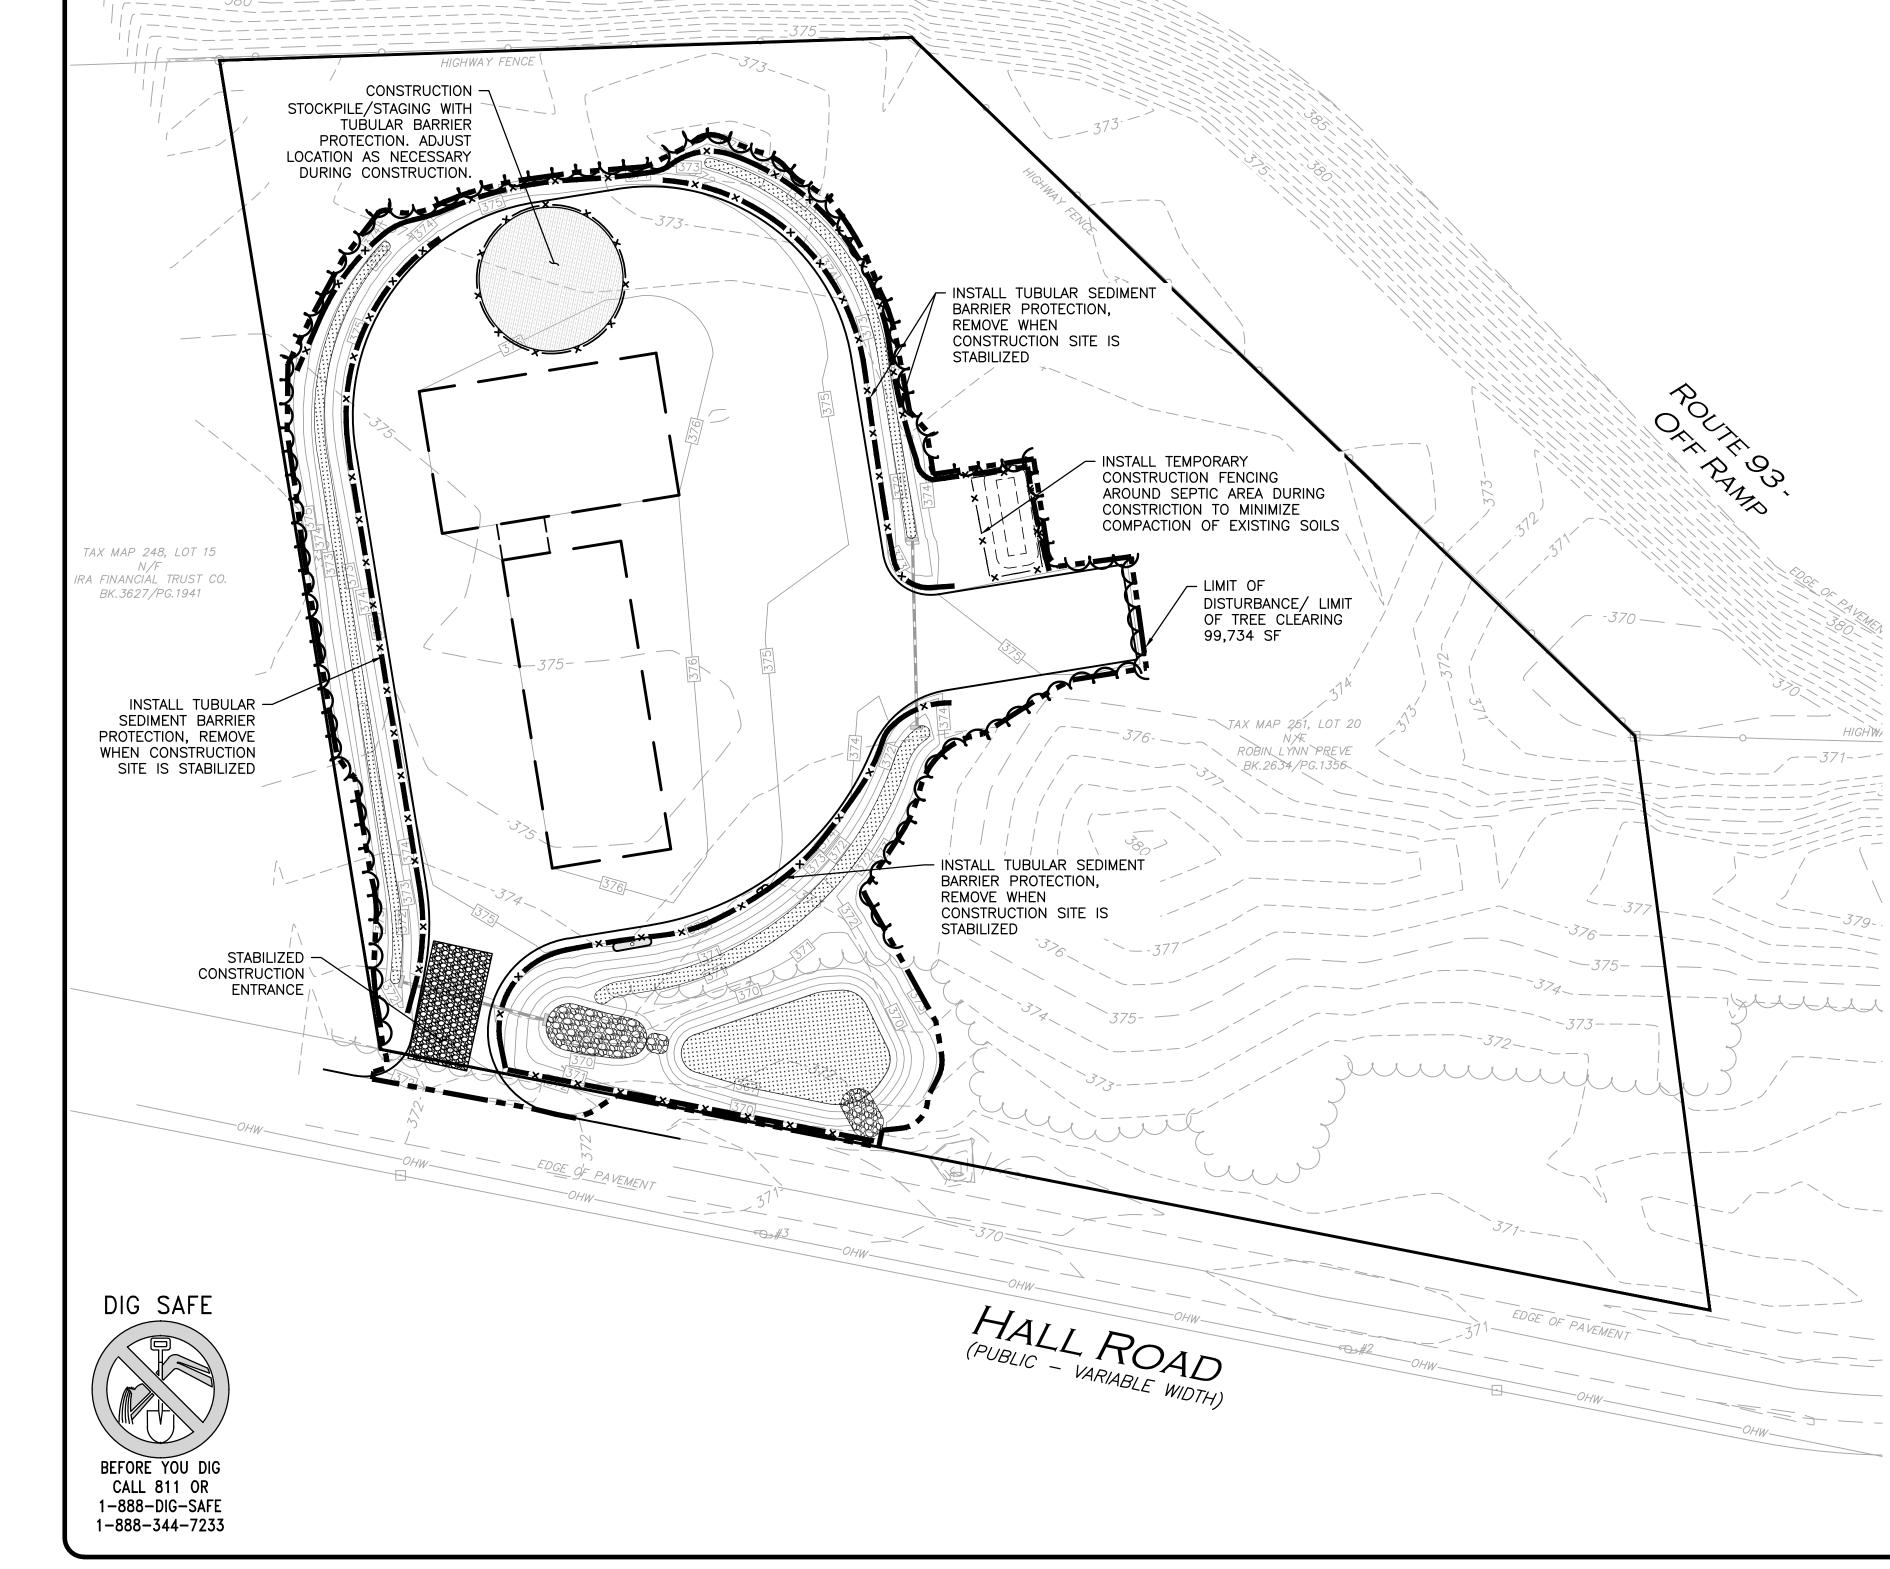

LUMINAIRE	LUMINAIRE SCHEDULE							
SYMBOL	LABEL	QTY	ARRANGEMENT	DESCRIPTION	[LUMCAT]	ARR. LUM. LUMENS	ARR. WATTS	LLF
••	LE	5	SINGLE	LEO AREA LIGHT, TYPE 4, CLEAR LENS, 16FT LENS	LE350-T4-HO-CLR	7726	73	0.850
•	TUMBLER	8	WALL	HEIGHT TUMBLER, TYPE 2. CLEAR LENS, WALL MOUNT	TML-16-A-1-TII-CLR	1739	20	0.850

CALCULATION SUMMARY							
LABEL	CALCTYPE	UNITS	AVG	MAX	MIN	AVG/MIN	MAX/MIN
ALL CALCULATION POINTS	ILLUMINANCE	FC	0.41	5.8	0.0	N.A.	N.A.

INTERSTATE ROUTE 93

(PUBLIC - VARIABLE WIDTH)

# **LEGEND**


TYPE 'B' SINGLE POLE LIGHT WALL MOUNT LIGHT LIGHTING LEVELS 0.0 0.1 0.2 0.4 0.6

GIVEN IN FOOT-CANDLES

# NOTES:

THE LOCATIONS OF EXISTING UNDERGROUND UTILITIES ARE SHOWN IN AN APPROXIMATE WAY ONLY AND HAVE NOT BEEN INDEPENDENTLY VERIFIED BY THE OWNER OR IT'S REPRESENTATIVE. THE CONTRACTOR SHALL DETERMINE THE EXACT LOCATION OF ALL EXISTING UTILITIES BEFORE COMMENCING WORK, AND AGREES TO BE FULLY RESPONSIBLE FOR ANY AND ALL DAMAGES WHICH MIGHT BE OCCASIONED BY THE CONTRACTOR'S FAILURE TO EXACTLY LOCATE AND PRESERVE ANY AND ALL UNDERGROUND UTILITIES.

- CONTROLS FOR ALL EXTERIOR LIGHTING BY BUILDING CONTRACTOR.
- WIRING OF BUILDING MOUNTED FIXTURES BY BUILDING CONTRACTOR.
- 4. THE INFORMATION SHOWN ON THIS PLAN IS THE SOLE PROPERTY OF ALLEN & MAJOR ASSOCIATES, INC. ITS INTENDED USE IS TO PROVIDE INFORMATION. ANY ALTERATION, MISUSE, OR RECALCULATION OF INFORMATION OR DATA WITHOUT THE EXPRESSED, WRITTEN CONSENT OF ALLEN & MAJOR ASSOCIATES, INC. IS STRICTLY PROHIBITED.

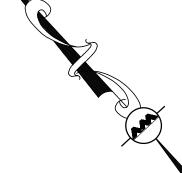

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> | 5-17-2021 | ISSUED FOR REVIEW DATE DESCRIPTION

REV APPLICANT\OWNER:

> STATION MEADOW, LLC 4 DUNLAP ROAD BURLINGTON, MA 01803

PROJECT:

TAX MAP 251, LOT 18 HALL ROAD CANTERBURY, NH

5/17/2021 2915-01 DATE: PROJECT NO. SCALE: 1" = **36**' DWG. NAME: ARM | CHECKED BY: **DESIGNED BY:** 

ALLEN & MAJOR

ASSOCIATES, INC. vil engineering • land surveying environmenta consulting ◆ landscape architecture www.allenmajor.com 400 HARVEY ROAD

MANCHESTER, NH 03103 TEL: (603) 627-5500 FAX: (603) 627-5501

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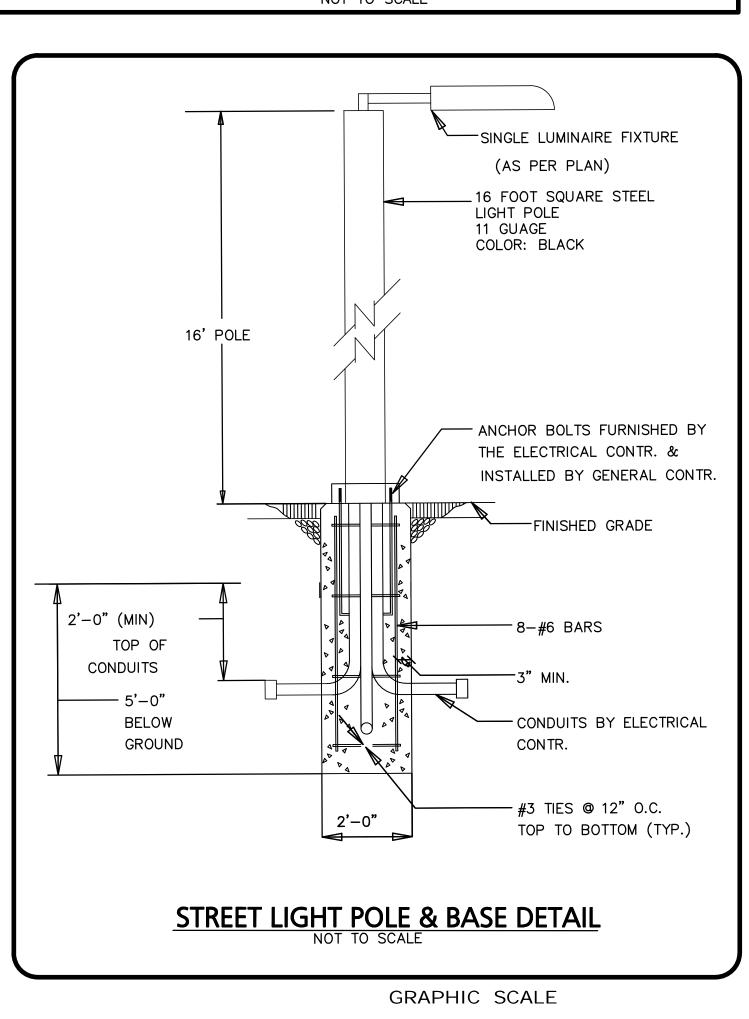
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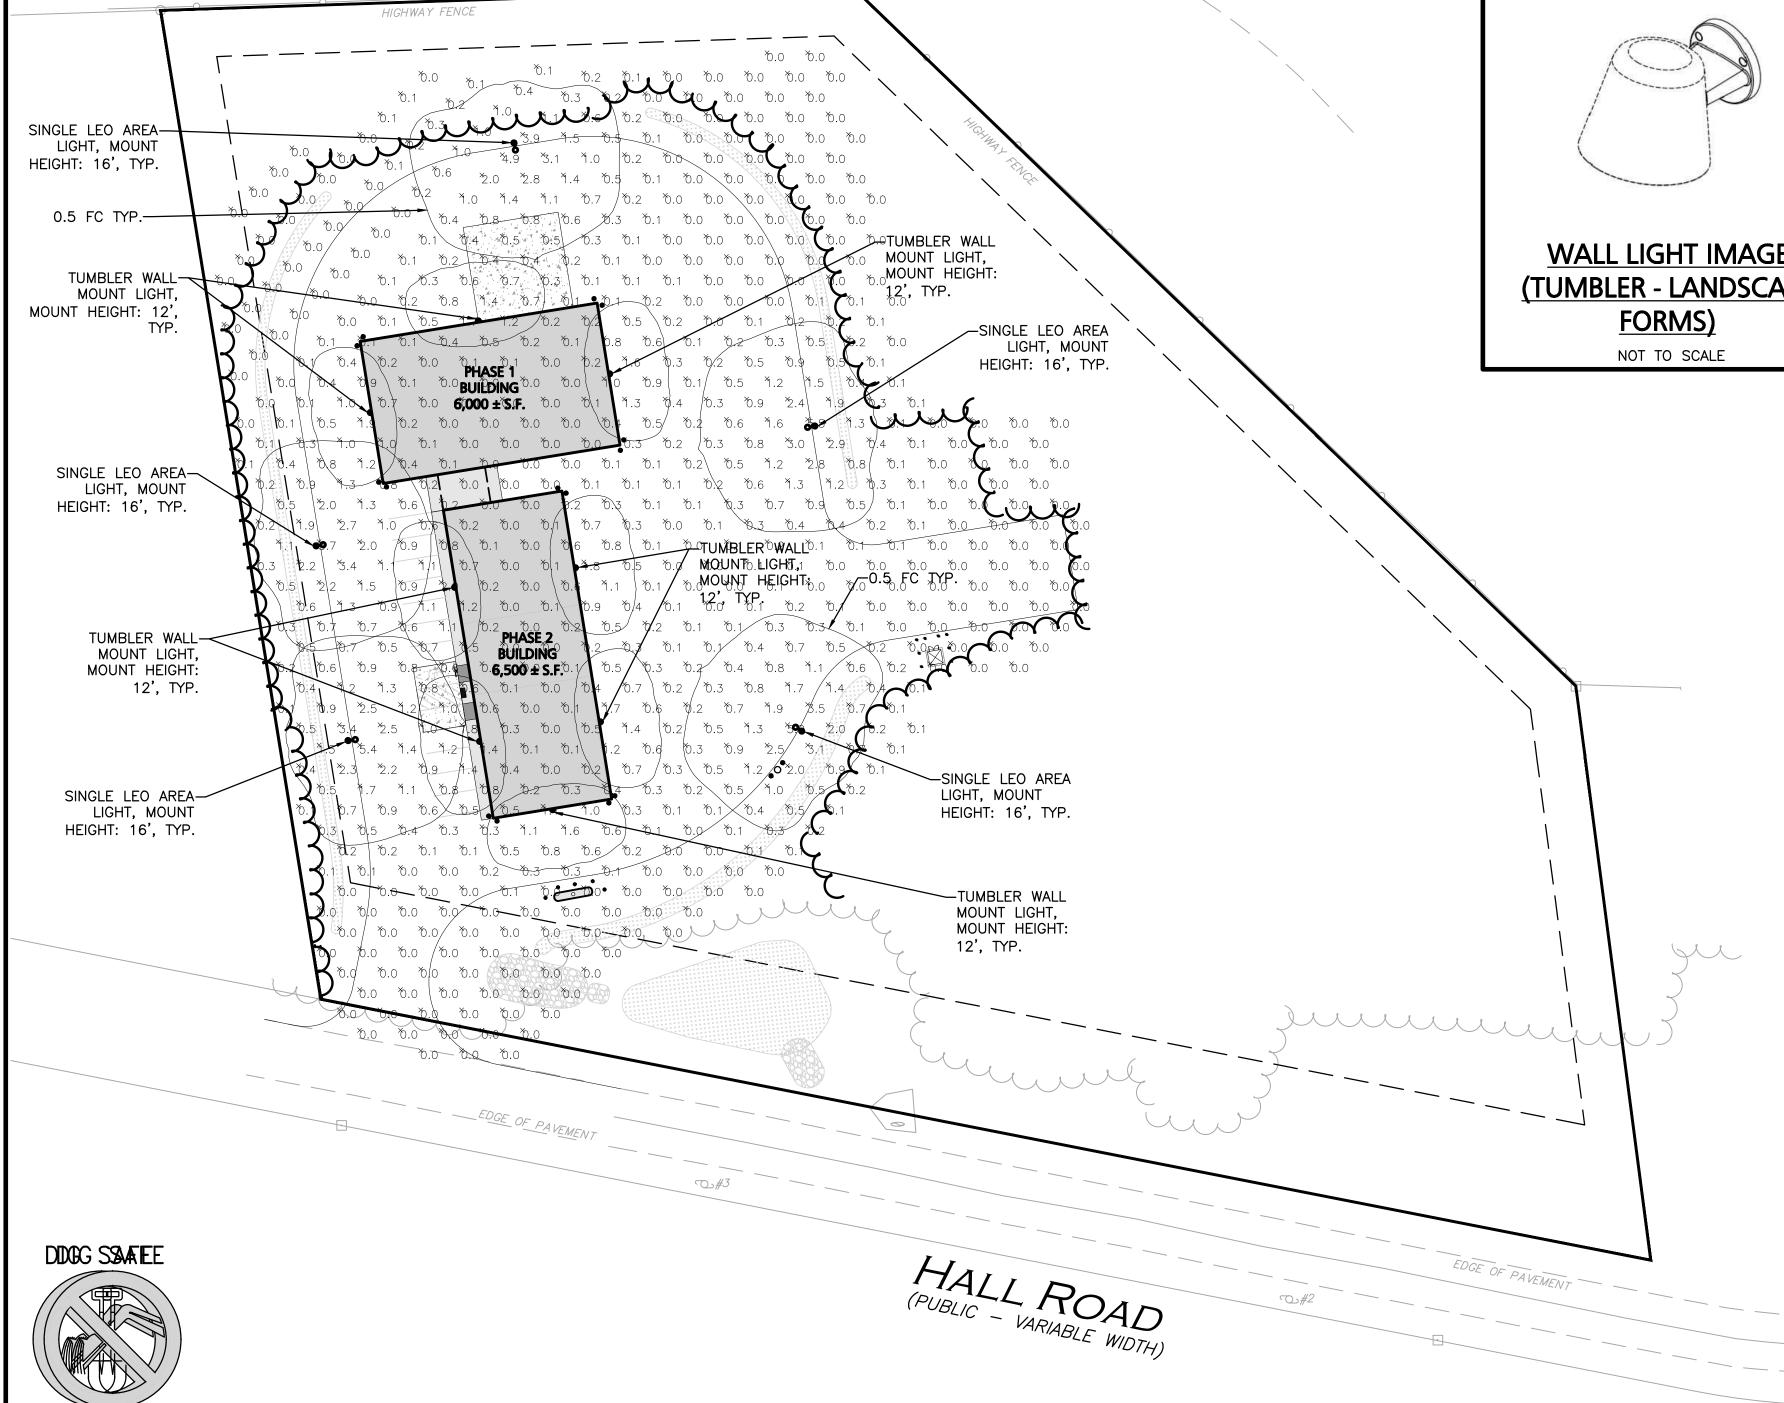
C-105 SITE LIGHTING PLAN

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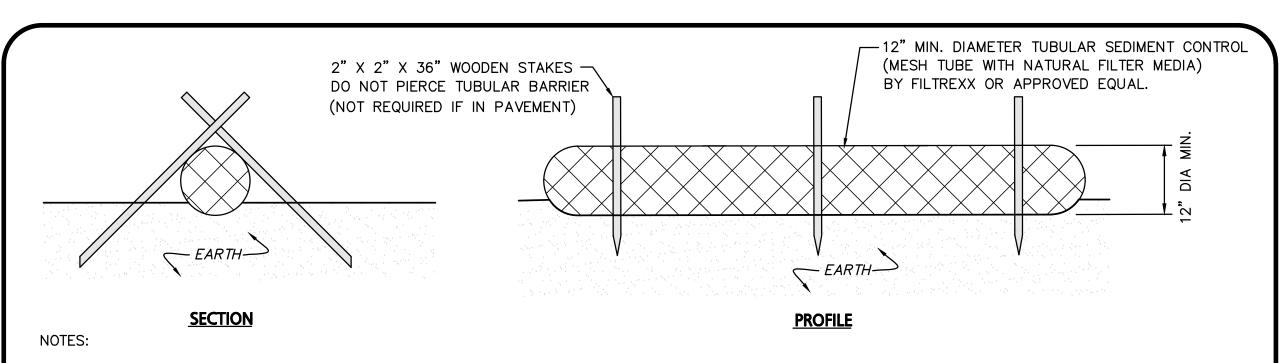


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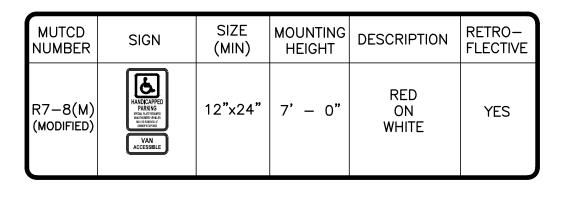
( IN FEET )

1 inch = #⊕ ft.




- 1. ALL MATERIALS TO MEET MANUFACTURERS SPECIFICATIONS.
- 2. INSTALL WOODEN STAKES IN A CRISS-CROSS PATTERN EVERY 8' ON CENTER.
- 2. OVERLAP TUBULAR BARRIER SEGMENTS A MINIMUM OF 12".
- 3. THE CONTRACTOR SHALL MAINTAIN THE TUBULAR BARRIERS IN A FUNCTIONAL CONDITION AT ALL TIMES. THE CONTROLS SHALL BE ROUTINELY INSPECTED BY THE CONTRACTOR.
- 4. WHERE THE TUBULAR BARRIERS REQUIRE REPAIR OR SEDIMENT REMOVAL, IT WILL BE COMPLETED BY THE CONTRACTOR AT NO ADDITIONAL COST.
- 5. AT A MINIMUM, THE CONTRACTOR SHALL REMOVE SEDIMENTS COLLECTED AT THE BASE WHEN THEY REACH 1/3 THE EXPOSED HEIGHT OF THE BARRIER.


# TUBULAR SEDIMENT BARRIER




1. TRAFFIC AND SAFETY SIGNAGE SHALL COMPLY WITH MUTCD

2. WHERE APPLICABLE THE SIGN SUPPORT SHALL COMPLY WITH THE BREAKAWAY REQUIREMENTS OF THE LATEST EDITION OF AASHTO'S "SPECIFICATION FOR STRUCTURAL SUPPORTS FOR HIGHWAY SIGNS, LUMINAIRIES, AND TRAFFIC SIGNALS".

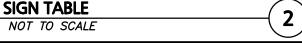

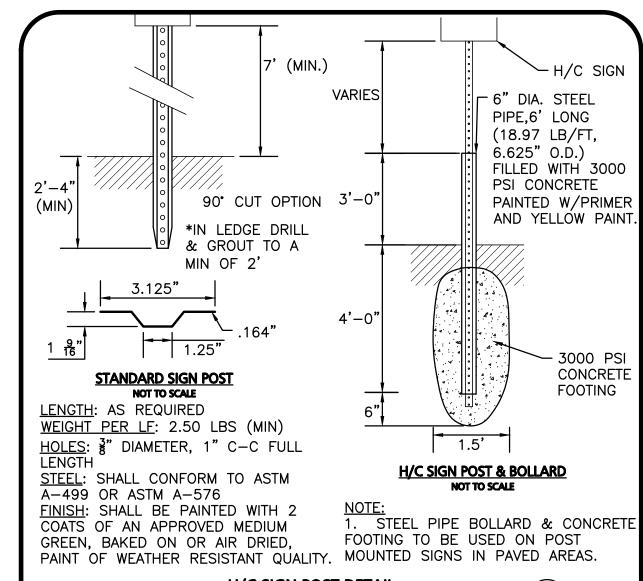

**H/C SIGN POST DETAIL** NOT TO SCALE

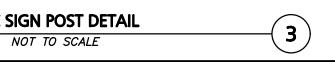

DIVERSION RIDGE REQUIRED WHERE GRADE EXCEEDS 2% EXISTING ROADWAY **SECTION A** -NON-WOVEN GEOTEXTILE TUBULAR SEDIMENT BARRIER, SAND BAGS, OR CONTINUOUS BERM OF EQUIVALENT HEIGHT **SEDIMENT** 2"-3" COURSE AGGREGATE (MIN.) MIN OF 6" THICK (MIN.)12' DIVERSION RIDGE


- 1. STONE SHALL BE 2 TO 3 INCH COURSE AGGREGATE.
- THE LENGTH OF THE STABILIZED ENTRANCE SHALL NOT BE LESS THAN 50 FEET.
- THE THICKNESS OF THE STONE FOR THE STABILIZED ENTRANCE SHALL NOT BE LESS THAN 6 INCHES.
- 4. THE WIDTH OF THE STABILIZED ENTRANCE SHALL NOT BE LESS THAN THE FULL WIDTH OF WHEREVER THE INGRESS/EGRESS OCCURS OR 12 FEET, WHICH EVER IS
- NON-WOVEN GEOTEXTILE SHALL BE PLACED OVER THE ENTRANCE AREA PRIOR TO PLACEMENT OF THE STONE.
- ALL SURFACE WATER THAT IS FLOWING TO OR DIVERTED TOWARD THE STABILIZED ENTRANCE SHALL BE PIPED BENEATH THE ENTRANCE. IF PIPING IS IMPRACTICAL, A BERM WITH 5:1 SLOPES THAT CAN BE CROSSED BY VEHICLES MAY BE SUBSTITUTED FOR THE PIPE.
- WHEELS SHALL BE CLEANED TO REMOVE MUD PRIOR TO EXIT ONTO PUBLIC RIGHTS-OF-WAY, WHEN WASHING IS REQUIRED, IT SHALL BE DONE ON AN AREA STABILIZED WITH STONE WHICH DRAINS INTO A SEDIMENT TRAP OR SEDIMENT BASIN.

# **MAINTENANCE:**

- MUD AND SOIL PARTICLES WILL EVENTUALLY CLOG THE VOIDS IN THE GRAVEL AND THE STABILIZED ENTRANCE WILL CEASE TO FUNCTION PROPERLY. WHEN THIS OCCURS. THE ENTRANCE SHOULD BE TOP DRESEED WITH NEW STONE. COMPLETE REPLACEMENT OF THE STABILIZED ENTRANCE MAY BE NECESSARY IF IT BECOMES COMPLETELY CLOGGED.
- IF WASHING FACILITIES ARE USED, THE SEDIMENT TRAP SHOULD BE CLEANED OUT AS OFTEN AS NECESSARY TO ASSURE THAT ADEQUATE TRAPPING EFFICIENCY AND STORAGE VOLUME IS AVAILABLE.







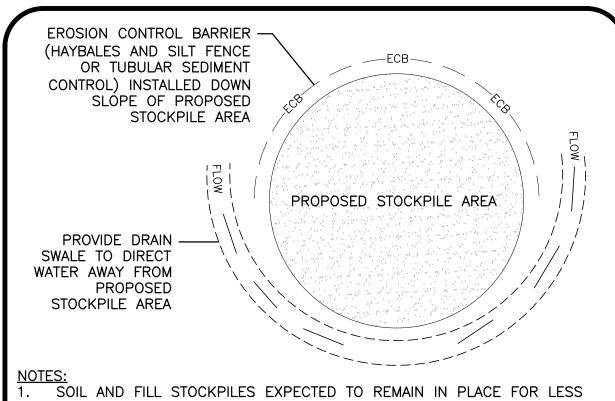

THAN 90 DAYS SHALL BE COVERED WITH HAY AND MULCH (AT 100LBS/1,000 SF), OR WITH AN ANCHORED TARP WITHIN 7 DAYS OR PRIOR TO ANY RAINFALL.

SOIL AND FILL STOCKPILES EXPECTED TO REMAIN IN PLACE FOR 90 DAYS OR MORE SHALL BE SEEDED WITH WINTER RYE (FOR FALL SEEDING AT 3LB/1,000 SF) OR OATS (FOR SUMMER SEEDING AT 2LB/1,000 SF) AND THEN COVERED WITH HAY MULCH (AT 100LB/1.000 SF) OR AN ANCHORED

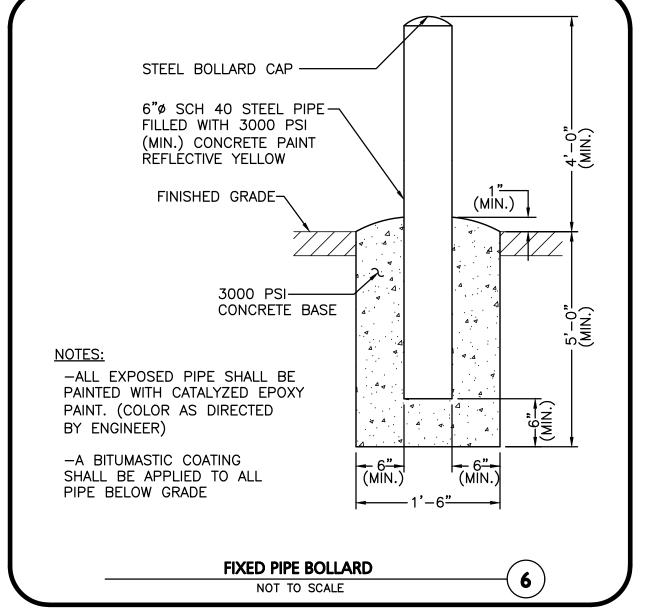

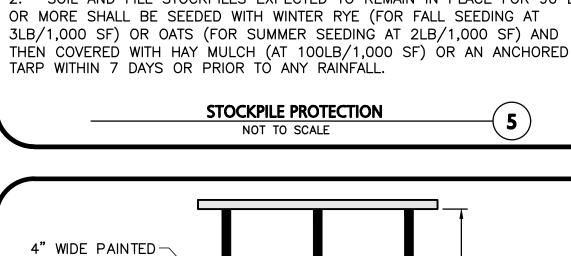

STANDARD STALL


HANDICAPPED PARKING¬€

SIGN/POST (SEE DETAIL)

WHITE LINES

NOTE: 1. "V" DENOTES HANDICAPPED

ACCESSIBLE PARKING SPACE.

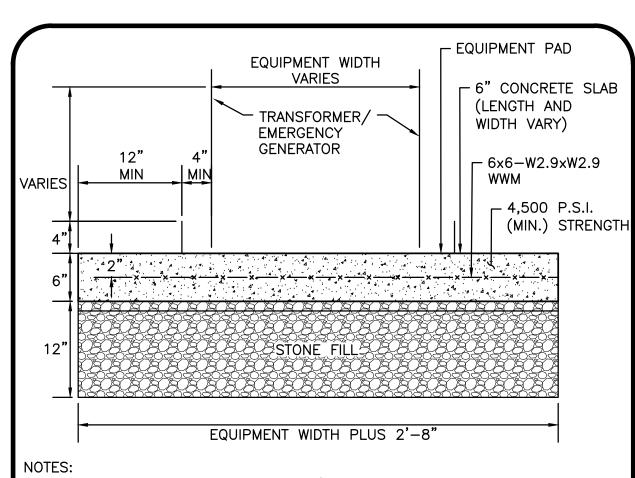



REFERENCE MECHANICAL ENGINEER'S PLANS FOR ANY PIPE, CONDUIT AND GROUND WIRE LOCATIONS.

NO BOLLARDS ARE CURRENTLY SHOWN AT TRANSFORMER PAD LOCATIONS, HOWEVER, BOLLARD REQUIREMENTS SHALL BE COORDINATED WITH SERVICE PROVIDER IN ACCORDANCE WITH THEIR REGULATIONS.

NOT TO SCALE

NHDOT ITEM 520.01 CEMENT CONCRETE STANDARD DUTY = 6" THICK --- EPOXY COATED #5 BAR @ 12" BOTH WAYS (CENTERED) (TYP) GRAVEL SURFACE — NHDOT ITEM 304.3 12" CRUSHED GRAVEL COMPACTED SUBGRADE I.CONSTRUCTION JOINTS TO BE SET AT INTERVALS OF 1/2 LENGTH, OR A MAXIMUM OF 25 FEET IN EITHER DIRECTION. 400 SQUARE FEET MAX. PANEL. 2.ALL REINFORCING STEEL SHALL BE EPOXY COATED PER NHDOT SPECIFICATIONS. 3.CONCRETE SHALL BE NHDOT CLASS AA 4.DOWELS SHALL BE #5 BARS SPACED 10" O.C. BOTH WAYS (CENTER) AT EACH CONSTRUCTION JOINT. 5. ALL CONSTRUCTION JOINTS TO INCLUDE A REGLET PER DETAIL TYPICAL CONCRETE APRON DETAIL NOT TO SCALE

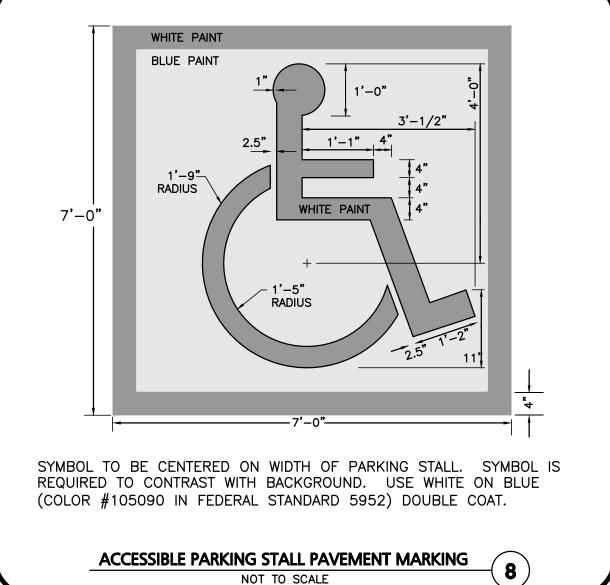

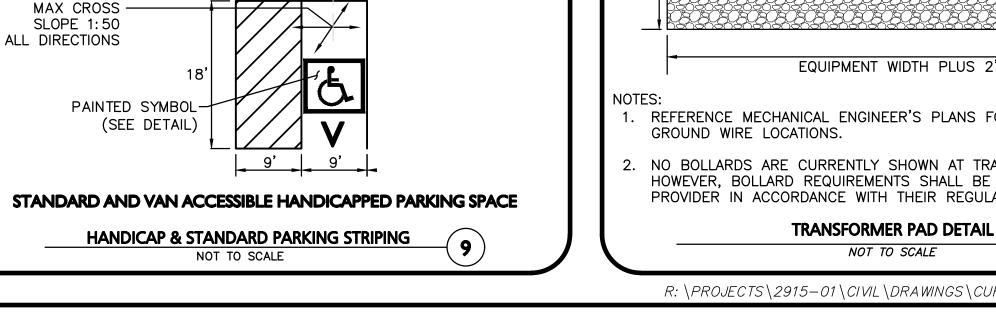


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(10)



PROFESSIONAL ENGINEER FOR ALLEN & MAJOR ASSOCIATES, INC.

5-17-2021 | ISSUED FOR REVIEW DATE DESCRIPTION APPLICANT\OWNER:

STATION MEADOW, LLC 4 DUNLAP ROAD **BURLINGTON, MA 01803** 

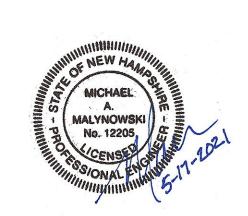PROJECT:

TAX MAP 251, LOT 18 HALL ROAD CANTERBURY, NH

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DESIGNED BY:	ARM	CHECKED BY:	М
SCALE:	AS SHOWN	DWG. NAME:	C2915
PROJECT NO.	2915-01	DATE:	5/17/2


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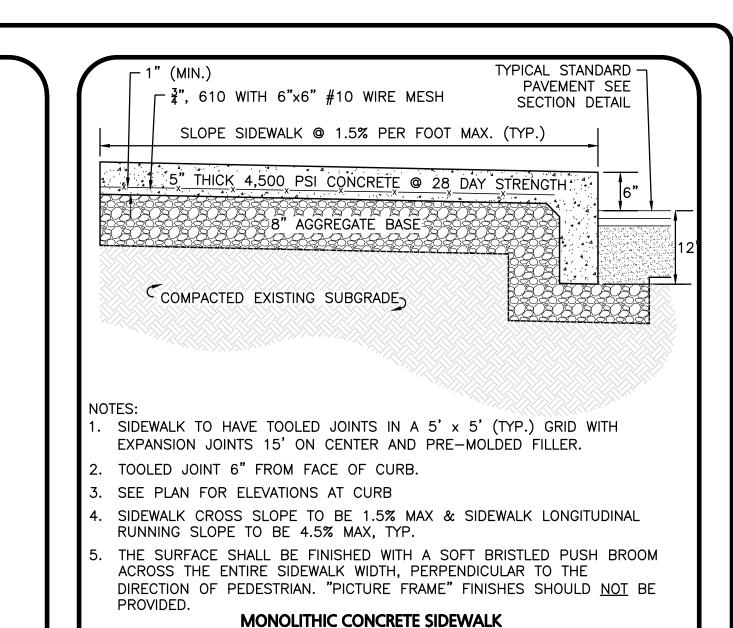
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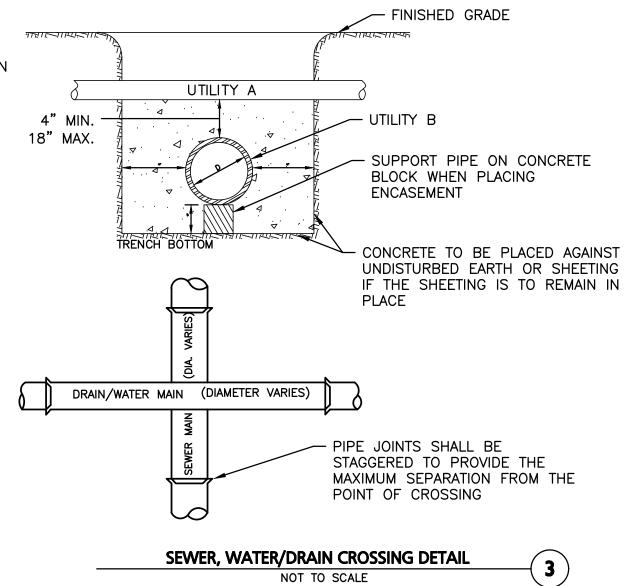
C-501







WHENEVER CONDITIONS PREVENT A LATERAL SEPARATION OF 10 FEET BETWEEN A SEWER MAIN AND A WATER/DRAIN MAIN:

- 1. THE WATER/DRAIN MAIN SHALL BE LAID IN A SEPARATE TRENCH AND THE DIFFERENCE IN ELEVATION BETWEEN THE WATER/DRAIN MAIN AND THE SEWER MAIN SHALL BE AT LEAST 18 INCHES.
- 2. THE PIPE CROSSING SHALL OCCUR AS CLOSE TO 90° AS PRACTICABLE.
- 3. THE PIPE JOINTS SHALL BE STAGGERED TO PROVIDE THE MAXIMUM SEPARATION FROM THE POINT OF CROSSING.
- 4. THE CROSSING SHALL BE ENCASED IN CONCRETE FOR THE ENTIRE WIDTH OF THE TRENCH AND FOR A DISTANCE OF 10 LINEAR FEET CENTERED ON THE CROSSING.
- 5. UTILITIES A AND B CAN BE EITHER NEW OR EXISTING.
- 6. WHEN ONE UTILITY IS A SANITARY SEWER. IT IS PREFERABLE TO BE POSITIONED AS SHOWN FOR UTILITY B.
- 7. ENCASEMENT EXTENDS 10'-0" ON EACH SIDE OF THE CENTERLINE OF UTILITY A.
- 8. PIPE MUST BE BRACED VERTICALLY AND HORIZONTALLY TO PREVENT FLOATATION DURING PLACEMENT OF CONCRETE.

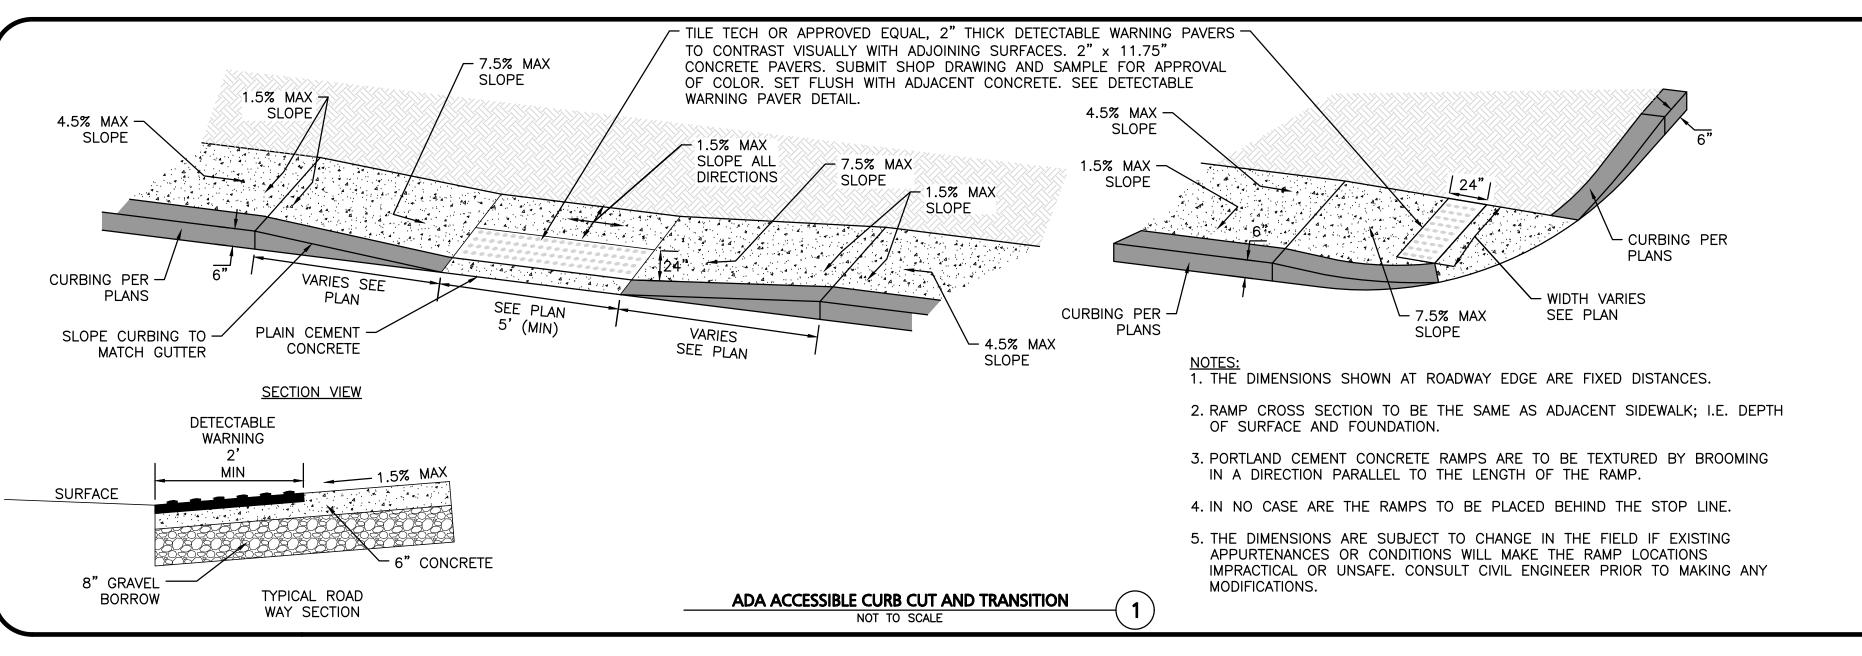

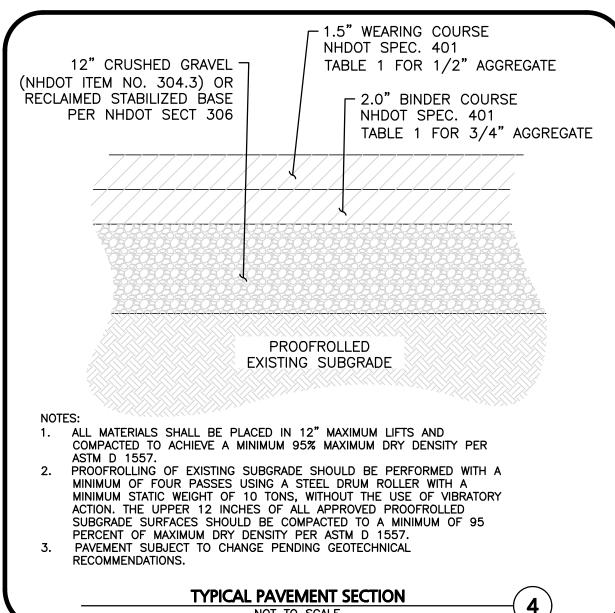

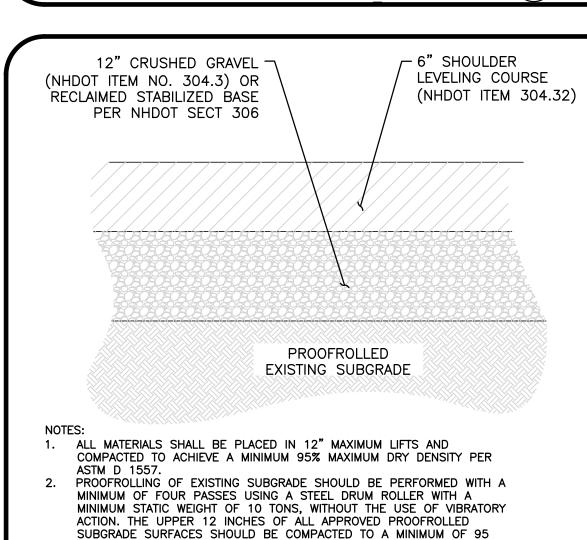

WITH 6" REVEAL

NOT TO SCALE

PERCENT OF MAXIMUM DRY DENSITY PER ASTM D 1557. PAVEMENT SUBJECT TO CHANGE PENDING GEOTECHNICAL

1. MINIMUM BURIAL DEPTH (FINISH GRADE TO TOP OF PIPE)

PIPES AND STRUCTURES MUST MEET THIS REQUIREMENT.

4. BACKFILL AS PER DCED-R100 AND REFERENCED AS STANDARD

2. WHERE BACKFILL IS DESIGNATED AS COMPACTED, THIS MEANS 90 TO

95% STANDARD PROCTOR. AASHTO T-99. ALL FILL PLACED BELOW

3. FOR ALL TRENCHES WITH A GRADE GREATER THAN 4% AND/OR WHERE

GROUNDWATER IS APPARENT, INSTALL CLAY DAMS AROUND THE PIPE

RECOMMENDATIONS.

GRAVITY PIPE - SEE PLAN OR PROFILE


PRESSURE PIPE BENEATH UNPAVED - 3'


PRESSURE PIPE UNDER PAVING - 4'

AT 100' INTERVALS.

DRAWING.

TYPICAL COMPACTED GRAVEL FINISHED SURFACE NOT TO SCALE

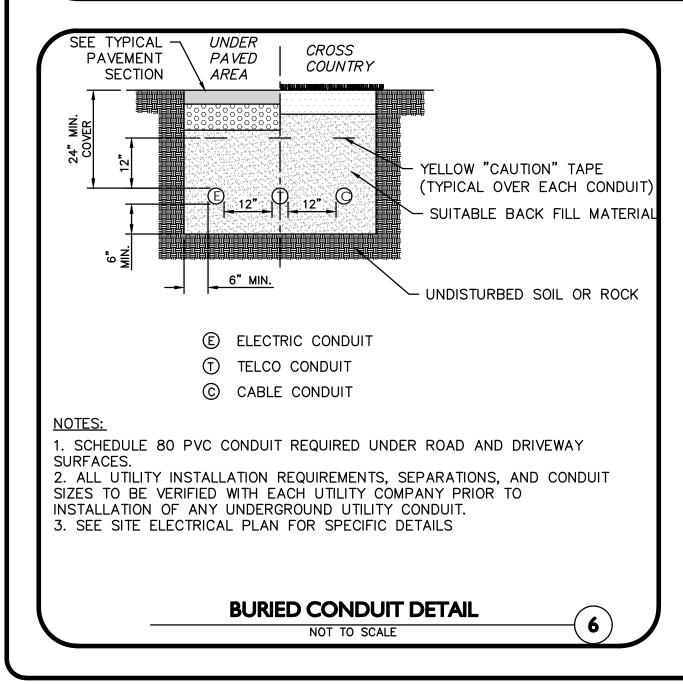

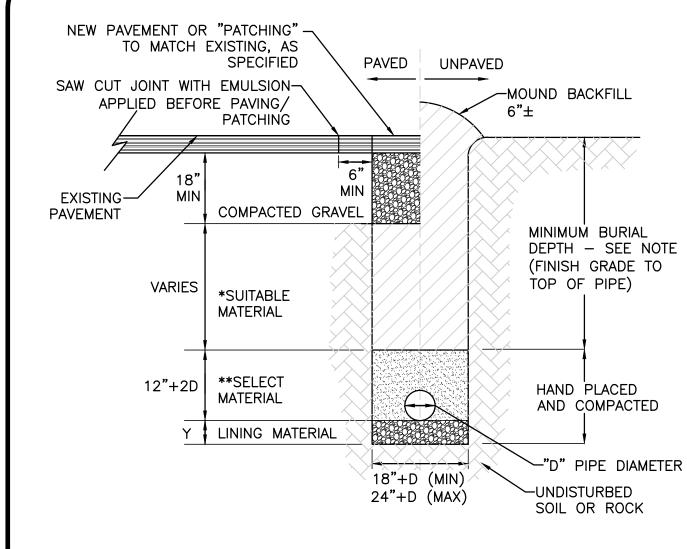

CONDITION & PIPE **SELECT MATERIAL LINING MATERIAL Y-DIMENSION  DUCTILE IRON 'ORDINARY SOIL" TYPE I, II, OR III SAND OR TYPE III 3"  RCP 'ORDINARY SOIL" TYPE II OR III SAND OR TYPE III 8"  ALL PIPE OVER BEDROCK OR LEDGE TYPE II OR III SAND OR TYPE III 8"  DUCTILE IRON IN CLAY TYPE II OR III SAND 8"  ALL PLASTICS TYPE II OR III SAND OR TYPE III 6"				
"ORDINARY SOIL"  TYPE I, II, OR III  SAND OR TYPE III  3"  RCP "ORDINARY SOIL"  TYPE II OR III  SAND OR TYPE III  3"  ALL PIPE OVER BEDROCK OR LEDGE  TYPE II OR III  SAND OR TYPE III  8"  DUCTILE IRON IN CLAY OR MUCK  TYPE II OR III  SAND  4"  RCP IN CLAY  TYPE II OR III  SAND  8"	CONDITION & PIPE	**SELECT MATERIAL	LINING MATERIAL	Y-DIMENSION
"ORDINARY SOIL"  TYPE II OR III  SAND OR TYPE III  3"  ALL PIPE OVER BEDROCK OR LEDGE  TYPE II OR III  SAND OR TYPE III  8"  DUCTILE IRON IN CLAY OR MUCK  TYPE II OR III  SAND  4"  RCP IN CLAY  TYPE II OR III  SAND  8"		TYPE I, II, OR III	SAND OR TYPE III	3"
BEDROCK OR LEDGE TYPE II OR III SAND OR TYPE III 8"  DUCTILE IRON IN CLAY OR MUCK TYPE II OR III SAND 4"  RCP IN CLAY TYPE II OR III SAND 8"		TYPE II OR III	SAND OR TYPE III	3"
CLAY OR MUCK TYPE II OR III SAND 4"  RCP IN CLAY TYPE II OR III SAND 8"		TYPE II OR III	SAND OR TYPE III	8"
		TYPE II OR III	SAND	4"
ALL PLASTICS TYPE III SAND OR TYPE III 6"	RCP IN CLAY	TYPE II OR III	SAND	8"
	ALL PLASTICS	TYPE III	SAND OR TYPE III	6"

- \* SUITABLE MATERIAL SHALL CONTAIN NO STONE GREATER THAN 4" IN DIAMETER, NO FROZEN LUMPS, AND ONLY MINOR AMOUNTS OF CLAY OR ORGANIC MATERIAL. ALL MATERIAL TO BE PLACED IN MAX 6" LIFTS AND COMPACTED BEFORE PLACING NEXT LIFT. \*\*TYPE I MATERIAL SHALL BE EITHER GRAVEL OR EXCAVATED MATERIAL CONTAINING NO STONES GREATER THAN 1.5" DIAMETER, NO FROZEN LUMPS, CLAY OR ORGANIC MATERIAL.
- \*\*TYPE II MATERIAL SHALL BE CLEAN, HARD, CRUSHED OR NATURAL STONE WITH A GRADATION BY WEIGHT OF 100% PASSING A 1.5" SQUARE OPENING, NOT MORE THAN 25% PASSING A 3" OPENING, AND NOT MORE THAN 5% PASSING A 1" SQUARE OPENING. \*\*TYPE III MATERIAL SHALL BE CLEAN, HARD, CRUSHED STONE FREE FROM COATINGS AND THOROUGHLY WASHED WITH A GRADATION BY
- WEIGHT OF 100% PASSING A 1" SQUARE OPENING, AND 0 TO 5% PASSING A 1" SQUARE OPENING.

TRENCH DETAIL (FOR SITE ONLY) NOT TO SCALE

PROFESSIONAL ENGINEER FOR ALLEN & MAJOR ASSOCIATES, INC.

MALYNOWSKI No. 12205

5-17-2021 | ISSUED FOR REVIEW DATE DESCRIPTION

APPLICANT\OWNER: STATION MEADOW, LLC 4 DUNLAP ROAD **BURLINGTON, MA 01803** 

PROJECT:

TAX MAP 251, LOT 18 HALL ROAD CANTERBURY, NH

PROJECT NO. 2915-01 DATE: 5/17/2021 **SCALE:** AS SHOWN DWG. NAME: C2915-0 **DESIGNED BY:** ARM | CHECKED BY:



ivil engineering ♦ land surveying environment; consulting ◆ landscape architecture www.allenmajor.com 400 HARVEY ROAD

MANCHESTER, NH 03103 TEL: (603) 627-5500 FAX: (603) 627-5501

WOBURN, MA ♦ LAKEVILLE, MA ♦ MANCHESTER, NE

SHEET No.

C-502

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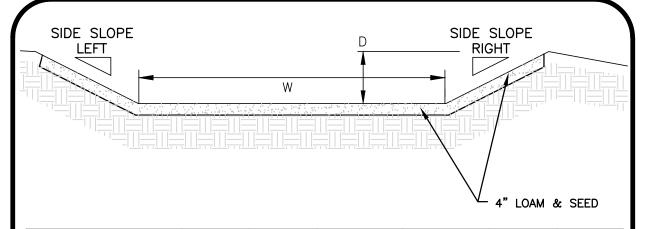
DRAWING TITLE:

**DETAILS** 

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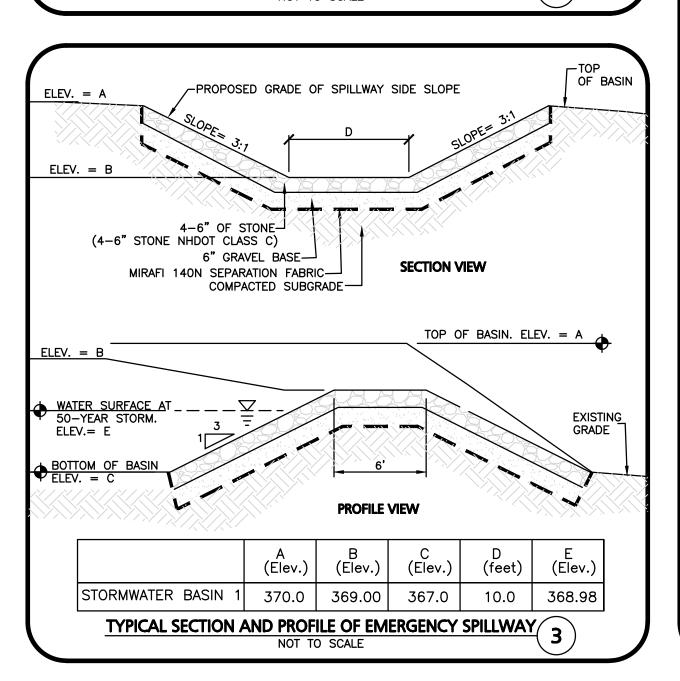


SWALE	W (FT)	D (FT)	SIDE SLOPE LEFT	SIDE SLOPE RIGHT	SLOPE	LENGTH (FT)
CONVEYANCE SWALE #1	4	1	3:1	3:1	0.50%	194
CONVEYANCE SWALE #2	6	1	3:1	3:1	0.50%	177
CONVEYANCE SWALE #3	4	1	3:1	3:1	0.50%	318

## **BASIN NOTES**

- MAINTENANCE REQUIRES PERIODIC MOWING OF SLOPES, REMOVAL OF WOODY VEGETATION FROM SLOPES, REMOVAL OF DEBRIS , REMOVAL OF ACCUMULATED SEDIMENT.
- 2. INSPECT AND REPAIR AS REQUIRED.
- 3. SWALES TO HAVE 4" TOPSOIL AND TYPICAL SEED MIX. SEE NOTES.

TYPICAL GRASS CONVEYANCE SWALE DETAIL




## TYPICAL LOAM AND SEED MIX


CONTRACTOR SHALL SEED ALL DISTURBED AREAS NOT NOTED TO RECEIVE OTHER MATERIALS, AND AT AREAS SHOWN ON THE PLAN PER SPECIFICATIONS BELOW


- 1. SEED TO BE SPREAD AT MINIMUM RATE OF 5 LBS. PER 1000 SQ.
- 2.SEEDING TO BE COMPLETED "IN SEASON" BETWEEN APRIL 1 TO JUNE 15 OR AUGUST 15 TO OCTOBER 1, EXCEPT FOR RESEEDING OF BARE SPOTS. IF UNABLE TO SEED WITHIN THESE TIMEFRAMES. CONTRACTOR TO INSTALL EROSION CONTROL MATS ON ALL SLOPES 3:1 AND OVER, HYDROSEED ALL EXPOSED AREAS, ADD SOIL STABILIZER "FLUX TERRA HP-FGM SOIL STABILIZER" AS MANUFACTURED BY "PROFILE" TO HYDROSEED (AT RATE OF 3,000 LBS PER ACRE), AT NO ADDITIONAL COST TO THE OWNER. CONTRACTOR TO COMPLETE ALL ABOVE "OUT OF SEASON" REQUIREMENTS AND THEN ALSO BE RESPONSIBLE FOR RE-GRADING AND RE-SEEDING ALL DISTURBED, ERODED, OR BARE SPOTS WITHIN NEXT CLOSEST PLANTING SEASON IN FALL OR SPRING AT NO ADDITIONAL COST TO OWNER. CONTRACTOR RESPONSIBLE FOR ALL MAINTENANCE UNTIL FINAL ACCEPTANCE OF LAWN AREAS INCLUDING: WATERING, ADDING FERTILIZERS AND LIME AND MOWING AT NO ADDITIONAL COST TO OWNER.
- 3.COMMERCIAL FERTILIZER SHALL BE APPLIED AT THE RATE OF 25 POUNDS PER 1000 SQ. FT. OR AS RECOMMENDED BY THE TESTING AGENCY. LIME TO BE SPREAD AT THE RATE OF 100 POUNDS PER 1000 SQ. FT OR AS RECOMMENDED BY THE TESTING AGENCY. COMMERCIAL FERTILIZER SHALL BE A COMPLETE FERTILIZER CONTAINING AT LEAST 50% OF THE NITROGEN OF WHICH IS DERIVED FROM NATURAL ORGANIZE SOURCES OF UREAFORM. IT SHALL CONTAIN THE FOLLOWING PERCENTAGES BY WEIGHT: NITROGEN (N) 10%, PHOSPHORUS (P) 6%, POTASH (K) 4%. LIME SHALL BE AN APPROVED AGRICULTURAL LIMESTONE CONTAINING NOT LESS THAN 85% OF TOTAL CARBONATES. LIMESTONE SHALL BE GROUND TO SUCH FINENESS THAT 50% WILL PASS A 100 MESH SIEVE AND 90% WILL PASS THROUGH A 20 MESH SIEVE.
- 4.LAWN AREAS TO BE SEEDED BY SOWING EVENLY WITH AN APPROVED MECHANICAL SEEDER AT THE RATE OF TEN POUNDS PER 1000 SQUARE FEET.
- 5. CONTRACTOR RESPONSIBLE FOR WATERING, MOWING, AND RESEEDING OF LAWN BARE SPOTS UNTIL A UNIFORM, HEALTHY STAND OF GRASS IS ESTABLISHED AND ACCEPTED.

SCIENTIFIC NAME	COMMON NAME	PROPORTION BY WEIGHT	PERCENT PURITY	PERCENT GERMINATION
FESTUCA RUBRA "RUBRA"	CREEPING RED FESCUE	37%	95%	90%
PAO PRAENTENSIS "BARON"	BARON KENTUCKY BLUEGRASS	40%	85%	90%
LOLIUM PERENNE "PALMER"	PALMER PERENNIAL RYEGRASS	15%	95%	90%
FESTUCA RUBRA COMMUTATA WILMA CHEWINGS WILMA		8%	95%	80%

TYPICAL LOAM AND SEED NOTES **(4)** 

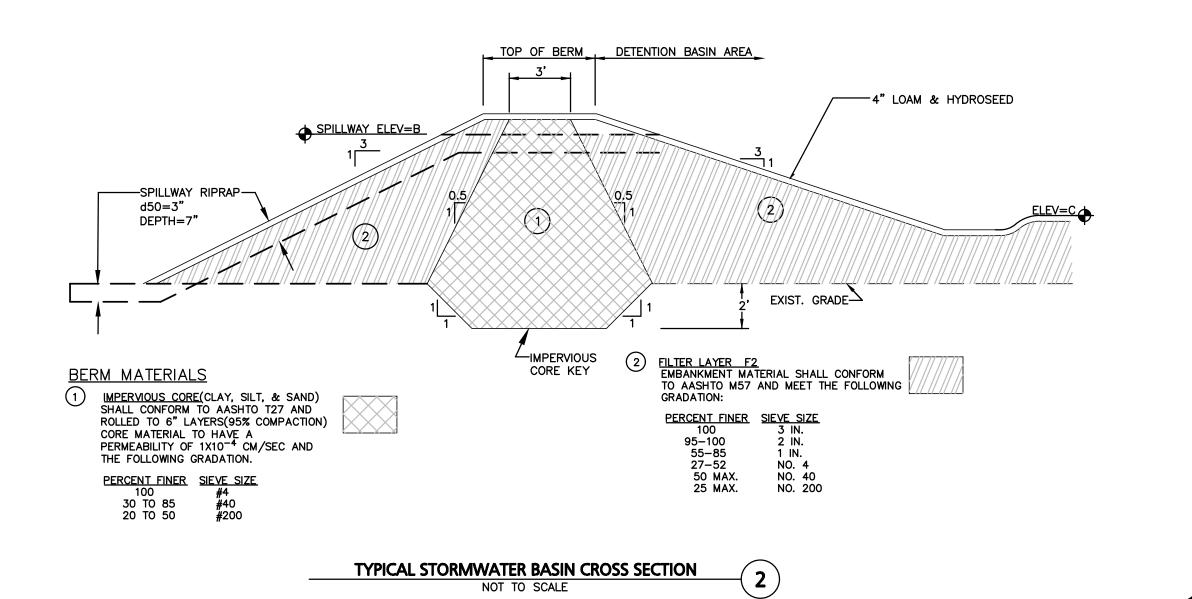

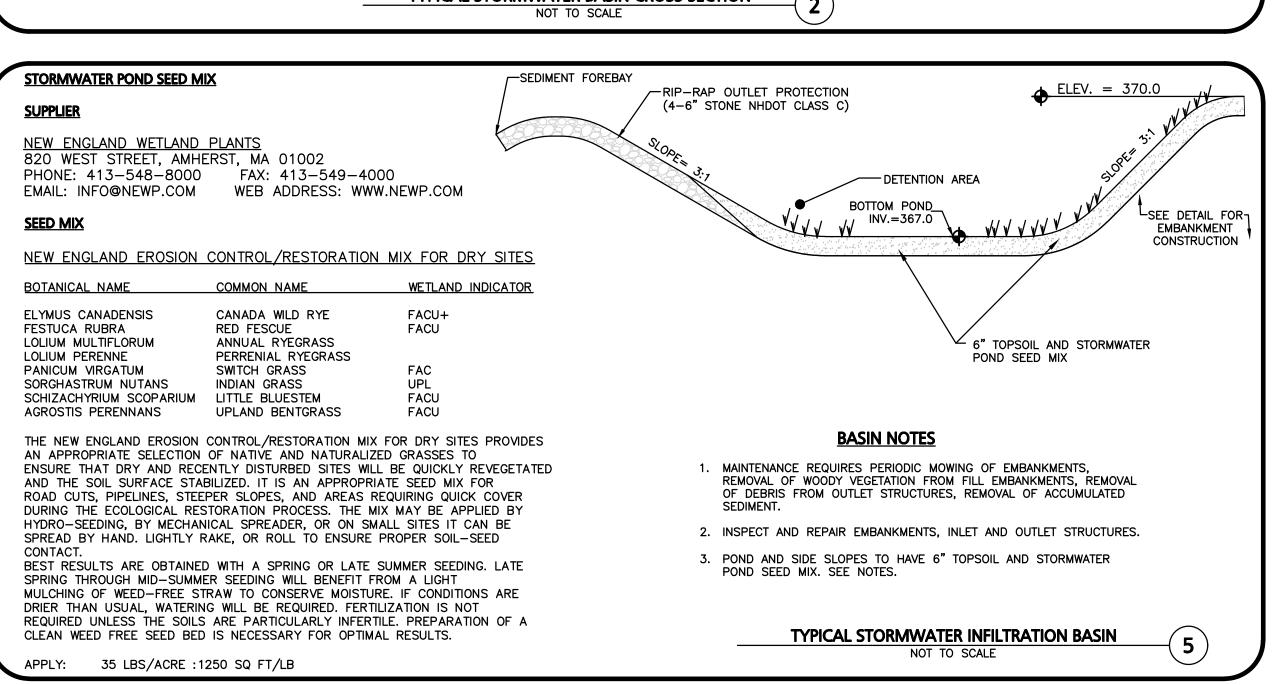

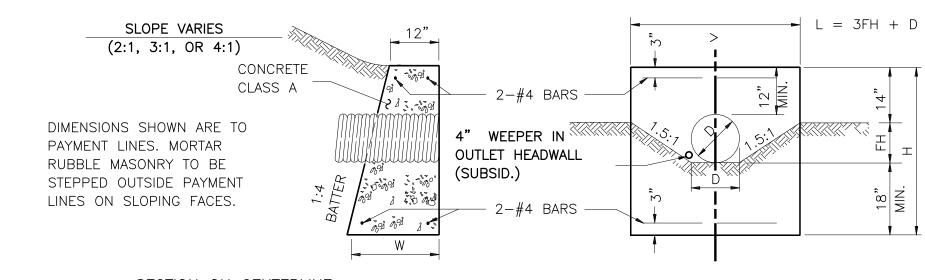


SECTION ON CENTERLINE

**ELEVATION** NOTE: STEEL QUANTITIES ARE FOR CONCRETE HEADWALLS ONLY.

	NOTE. STEEL QUANTILES ARE FOR CONCRETE HEADWALES ONET.								INLI,		
DIAMETER D INCHES D CU. YD	MASONRY	MASONRY PER	STEEL PER	LENOTH	EVO	LIEADED	LIEADED		WIDTH AT	"L" HEADWALL	
	STANDARD HEADER CU. YD.	STANDARD HEADER LB.	LENGTH OF BARS	EXC. FOR 1' DEPTH CU. YD.	HEADER LENGTH L	HEADER HEIGHT H	FILL HEIGHT FH	BOTTOM OF HEADER W	MASONRY IN CORNER FRUSTUM CU. YD.	EXC. FOR 1' DEPTH CU. YD.	
12	0.186	0.61	9	3'-2"	0.789	3'-6"	3'-6"	0'-10"	0'-10 1/2"	0.28	1.057
15	0.202	0.85	11	3-10	0.947	4-6	3-9	1-1	1-11 1/4	0.31	1.232
18	0.222	1.13	14	5-2	1.111	5-6	4-0	1-4	2-0	0.35	1.406
24	0.260	1.78	20	7-2	1.451	7-6	4-6	1-10	2-1 1/2	0.42	1.776

SINGLE PIPE HEADWALL DETAIL NOT TO SCALE

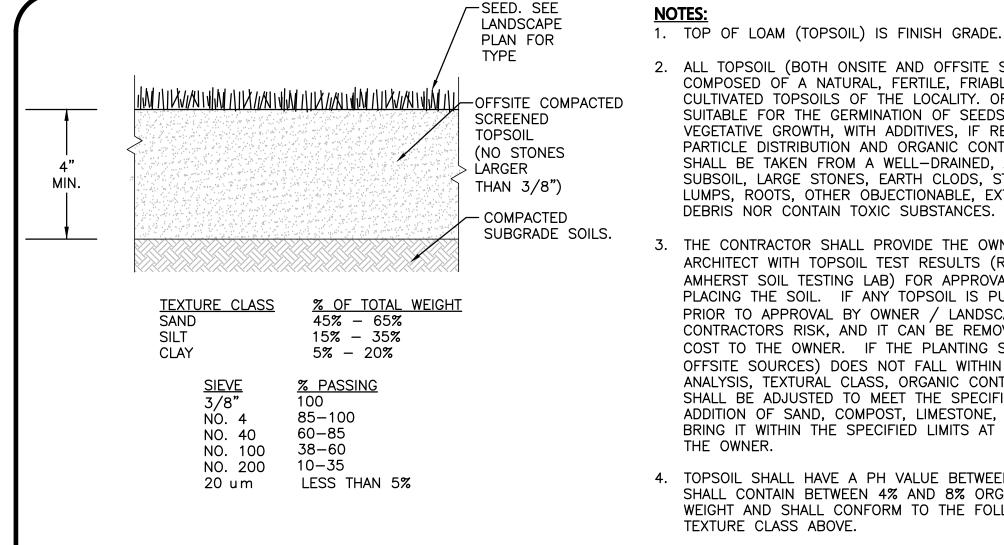

- 2. ALL TOPSOIL (BOTH ONSITE AND OFFSITE SOURCES) SHALL BE COMPOSED OF A NATURAL, FERTILE, FRIABLE SOIL TYPICAL OF CULTIVATED TOPSOILS OF THE LOCALITY. OFFSITE SOIL SHALL BE SUITABLE FOR THE GERMINATION OF SEEDS AND SUPPORT OF VEGETATIVE GROWTH, WITH ADDITIVES, IF REQUIRED, TO ACHIEVE PARTICLE DISTRIBUTION AND ORGANIC CONTENT BELOW. TOPSOIL SHALL BE TAKEN FROM A WELL-DRAINED, ARIABLE SITE, FREE OF SUBSOIL, LARGE STONES, EARTH CLODS, STICKS, STUMPS, CLAY LUMPS, ROOTS, OTHER OBJECTIONABLE, EXTRANEOUS MATTER OR DEBRIS NOR CONTAIN TOXIC SUBSTANCES.
- 3. THE CONTRACTOR SHALL PROVIDE THE OWNER / LANDSCAPE ARCHITECT WITH TOPSOIL TEST RESULTS (RECOMMEND UMASS AMHERST SOIL TESTING LAB) FOR APPROVAL PRIOR TO OBTAINING AND PLACING THE SOIL. IF ANY TOPSOIL IS PURCHASED OR PLACED PRIOR TO APPROVAL BY OWNER / LANDSCAPE ARCHITECT, IT IS AT CONTRACTORS RISK, AND IT CAN BE REMOVED AT NO ADDITIONAL COST TO THE OWNER. IF THE PLANTING SOIL (BOTH ONSITE AND OFFSITE SOURCES) DOES NOT FALL WITHIN THE REQUIRED SIEVE ANALYSIS, TEXTURAL CLASS, ORGANIC CONTENT, OR PH RANGE, IT SHALL BE ADJUSTED TO MEET THE SPECIFICATIONS THROUGH THE ADDITION OF SAND, COMPOST, LIMESTONE, OR ALUMINUM SULFATE TO BRING IT WITHIN THE SPECIFIED LIMITS AT NO ADDITIONAL COST TO
- 4. TOPSOIL SHALL HAVE A PH VALUE BETWEEN 5.5 AND 6.5. TOPSOIL SHALL CONTAIN BETWEEN 4% AND 8% ORGANIC MATTER OF TOTAL DRY WEIGHT AND SHALL CONFORM TO THE FOLLOWING GRADATION AND TEXTURE CLASS ABOVE.

**TOPSOIL FOR LAWN, SWALES** NOT TO SCALE

 $R: \PROJECTS \2915-01 \CIVIL \DRAWINGS \CURRENT \C-2915-01 \DETAILS.DWG$ 



PROFESSIONAL ENGINEER FOR ALLEN & MAJOR ASSOCIATES, INC.

5-17-2021 | ISSUED FOR REVIEW DATE DESCRIPTION

APPLICANT\OWNER:

STATION MEADOW, LLC 4 DUNLAP ROAD **BURLINGTON, MA 01803** 

TAX MAP 251, LOT 18 HALL ROAD CANTERBURY, NH

2915-01 DATE: PROJECT NO. 5/17/2021 SCALE: AS SHOWN DWG, NAME: C2915-0 ARM | CHECKED BY: **DESIGNED BY:** 



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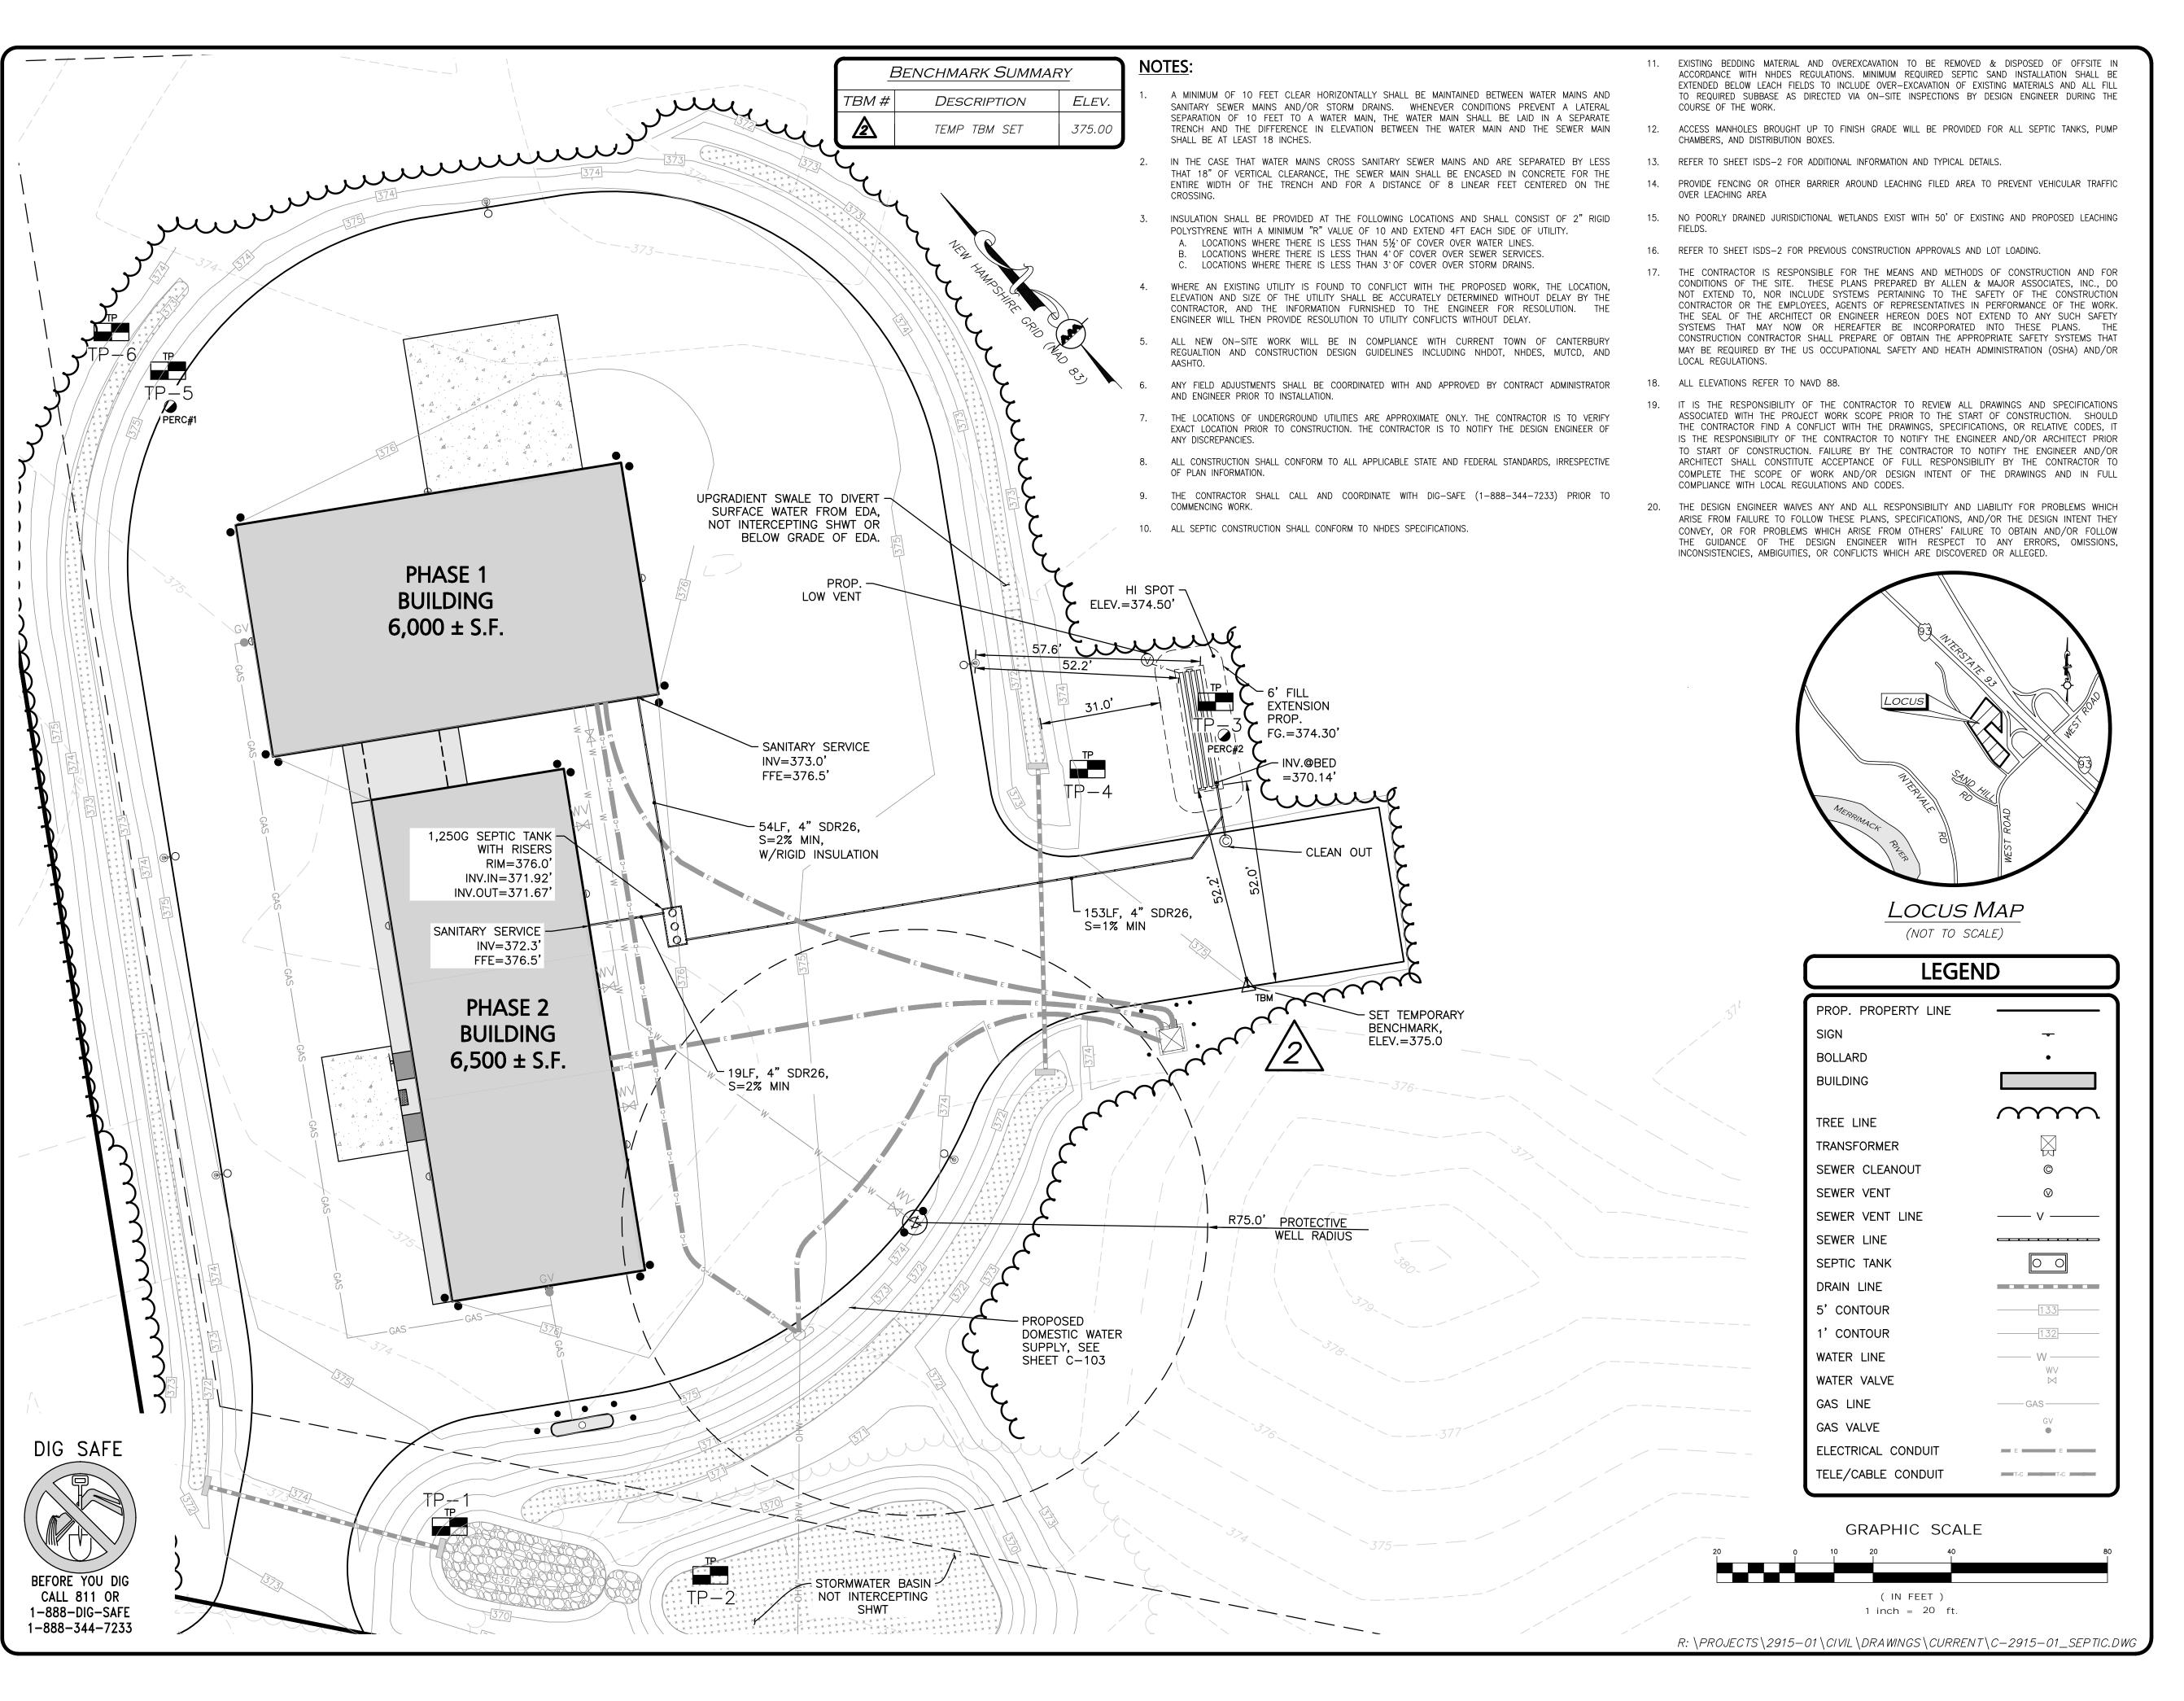
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www.allenmajor.com

400 HARVEY ROAD

MANCHESTER, NH 03103

TEL: (603) 627-5500 FAX: (603) 627-5501

Substituce Discour

MICHAEL A.

MALVIOWSK

NHDES DESIGNER OF SUBSURFACE SYSTEM FOR

ALLEN & MAJOR ASSOCIATES, INC.

5-17-2021 | ISSUED FOR REVIEW

DATE DESCRIPTION

STATION MEADOW, LLC

**BURLINGTON, MA 01803** 

TAX MAP 251, LOT 18

HALL ROAD

CANTERBURY, NH

2915-01 DATE:

1" = 20' DWG. NAME:

ARM | CHECKED BY:

5/17/2021

SHEET No.

ISDS-1

4 DUNLAP ROAD

APPLICANT\OWNER:

PROJECT:

PROJECT NO.

**DESIGNED BY:** 

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DRAWING TITLE:

INDIVIDUAL SUBSURFACE DISPOSAL SYSTEM

# **GENERAL NOTES**

- 1) THIS PLAN IS FOR THE DESIGN AND CONSTRUCTION OF THE PROPOSED SEPTIC SYSTEM AND APPURTENANCES ONLY. IT IS NOT TO BE USED FOR THE DETERMINATION OF BOUNDARIES, THE ERECTION OF BUILDINGS, OR ANY OTHER USE.
- 2) NO VEHICLES OR HEAVY MACHINERY SHALL NOT BE PERMITTED TO PASS OVER THE DISPOSAL AREA.
- INSTALLATION OF ALL SEPTIC SYSTEM COMPONENTS SHALL BE PERFORMED BY A LICENSED NH SEPTIC INSTALLER. CONTRACTOR SHALL VERIFY LOCATION, ELEVATION, AND SETBACK DISTANCES PRIOR TO CONSTRUCTION. ANY DISCREPANCY BETWEEN THIS PLAN AND THE APPARENT FIELD CONDITIONS SHALL BE REPORTED TO AND COORDINATED WITH THE DESIGNER, ALL VENDORS AND SITE OWNER IMMEDIATELY BY CONTRACTOR PRIOR TO PROCEEDING WITH WORK.
- 4) THE CONTRACTOR SHALL COORDINATE INSPECTION OF SEPTIC SYSTEM INSTALLATION WITH, HEALTH OFFICE AND NHDES.
- 5) PRIOR TO THE START OF EXCAVATION ACTIVITIES, THE CONTRACTOR IS TO HAVE COORDINATED WITH DIG-SAFE (888-344-7233).
- 6) NO CHANGES ARE TO BE MADE DURING CONSTRUCTION UNLESS PRE—APPROVED BY NHDES, THE SITE OWNER, THE DESIGNER AND THE TOWN HEALTH OFFICER. ALL CHANGES ARE TO BE COORDINATED BY THE CONTRACTOR.
- INSTALLATION SHALL BE PERFORMED IN ACCORDANCE WITH ALL REGULATIONS AND PER THE DIRECTION OF NHDES AND APPLICABLE PRODUCT VENDORS. INSTALLATION GUIDELINES SHALL BE FOLLOWED, INCLUDING THE APPROPRIATE DESIGN AND INSTALLATION MANUALS FOR ALL SYSTEMS.
- INTRODUCTION OF WASTE OTHER THAN NORMAL SEWAGE INTO THE SEPTIC SYSTEM IS NOT PERMITTED. THE DISPOSAL OF PH LOWERING AGENTS SUCH AS FLOOR STRIPPERS ARE PROHIBITED. NO CHEMICALS IN CONCENTRATIONS OR COMBINATIONS THAT WILL BE HARMFUL TO THE SEPTIC SYSTEM OR DEGRADE GROUNDWATER RESOURCES SHALL BE INTRODUCED TO THE SEPTIC SYSTEM. NO CLEANING AGENTS, SOLVENTS OR CHEMICALS OTHERWISE HAZARDOUS TO THE SEPTIC SYSTEM SHALL BE DISCHARGED TO THE SEPTIC SYSTEM. NO FILTER BACKWASHES, HOT TUBS, GARBAGE DISPOSALS, FOOD PRODUCT OR WASTE, FLOOR DRAINS, CONDENSATE DRAINS, OR HUMIDIFICATION DRAINS SHALL BE PLUMBED TO THE SEPTIC SYSTEMS. HOLDING TANKS SHALL BE UTILIZED (VIA NHDES REQUIREMENTS) FOR ALL FLOWS NOT ALLOWED INTO THE SEPTIC SYSTEMS (BY OTHERS).
- 9) LEACHFIELD(S) ARE TO BE REBUILT IN PLACE IF REPLACEMENT BECOMES NECESSARY.

ON THESE PLANS. DETAILS ON THESE PLANS MAY BE PROTOTYPICAL ONLY.

- PRIOR TO SYSTEM INSTALLATIONS, SHOP DRAWINGS OF ALL COMPONENTS AND DETAILS SHALL BE SUBMITTED FOR REVIEW. REVIEWS SHALL INCLUDE THOSE BY PRESBY ENVIRONMENTAL, PUMP VENDOR, TANK SUPPLIERS, ETC. FOR ALL COMPONENTS AND DETAILS, WHICH ARE NOT NECESSARILY DEPICTED
- 11) PLANTINGS IN THE VICINITY OF THE LEACH FIELD SHALL BE COORDINATED WITH DESIGNER SO AS TO NOT ADVERSELY IMPACT THE SEPTIC SYSTEM.
- 13) ALL WATER LINES SHALL BE 25' MINIMUM SETBACK FROM LEACHING FIELDS.
- 14) ALL CONCRETE PRODUCTS TO BE MANUFACTURED BY PHOENIX PRECAST OR APPROVED EQUAL, UNLESS OTHERWISE NOTED ON THE PLANS ALL TANKS AND EQUIPMENTS SYSTEMS SHALL CONFORM TO NHDES REGULATIONS.
- 15) CONCRETE STRUCTURES TO BE WATER TIGHT. ALL JOINTS, INLETS, OUTLETS, ETC. TO BE SEALED WITH NON-SHRINK GROUT "WATER PLUG", "BLOCK BOND" OR APPROVED EQUAL.
- 16) SYSTEM TO BE INSPECTED AND APPROVED BY THE TOWN & STATE PRIOR TO BACKFILLING IN ACCORDANCE WITH APPLICABLE REGULATIONS.
- 17) CONTRACTOR TO PROVIDE COMPLETE RECORDS OF ONGOING CONSTRUCTION ACTIVITIES, INCLUDING PHOTO LOGS OF ALL WORK AND REDLINES & MEASURED DRAWINGS OF ALL COMPONENTS PLACED AS WORK PROGRESSES, MATERIALS TESTING AND CERTIFICATIONS, INSPECTION REPORTS, DAILY CONSTRUCTION MANAGER'S LOGS, AND OTHER GENERAL CONTRACTOR RECORDS.
- 18) CONTRACTOR SHALL COORDINATE WITH ALL VENDORS AND PROVIDE DETAIL SHOP DRAWINGS OF ALL SYSTEMS, FITTINGS, ETC. FOR REVIEW & APPROVAL PRIOR TO COMMENCEMENT OF ORDERING MATERIALS
- 19) DO NOT INSTALL ON FROZEN GROUND OR LEAVE SYSTEM UNCOVERED FOR EXTENDED PERIODS OF TIME.
- 20) ALL DISTRIBUTION PIPES OR COMPONENTS WITH LESS THAN 4' OF COVER ARE TO BE PROVIDED WITH RIGID INSULATION.

### **DESIGN NOTES**

1) DESIGN INTENT:
LEACH FIELD: BOTTOM OF "ADVANCED ENVIRO—SEPTIC" PIPE TO BE SET
4.46 FT BELOW EXISTING GRADE AT ELEV.= 369.54'.

SEWAGE LOADING: 5.05 AC. X 2000 GPD/AC. = 10,100 GPD (SOIL CLASS 1)

DESIGN PERCOLATION RATE: 1 MIN. PER INCH BASED ON ACTUAL PERC TEST. (TO DEPTH OF 16")

PROPOSED DESIGN CRITERIA: ENV.-WQ 1008-01 (TABLE 1008-1) 10 GPD/EMPLOYEE X 20 EMPLOYEES = 200 GPD MINIMUM SIZE = 300 GPD

LEACHING AREA DESIGN CRITERIA (TABLE 1016-1): 125SF/PER 100GPD = 375SF FIELD: CONVENTIONAL FIELD: @ 2 MIN PER INCH = 375SF REQUIRED -40% REDUCTION FOR CHAMBERS = 375 X .60 = 225 SF REQUIRED

REQUIRED LENGTH OF ADVANCED ENVIRO—SEPTIC PIPE: (FROM PRESBY ENVIRONMENTAL TABLE A) PERC. RATE 1—2MPI 47 FT PER 100 GPD REQUIRED: 141 LF

- 3) SEPTIC TANK: SEE ENV-WQ 1010.02a & 1010.01b @ 300 GPD = 1250 GAL TANK SHALL BE PRECAST PER ENV-WQ 1010 AND AS MANUFACTURED BY PHOENIX PRECAST OR APPROVED EQUAL
- 4) WATER SUPPLY: PROPOSED WELL.

PROVIDED: 160 LF

- 5) LEACH FIELD PROXIMITY TO ABUTTING FEATURES: NEAREST SURFACE WATER: >75 FT. NEAREST WELL: >75 FT.
- 6) ADVANCED ENVIRO—SEPTIC (AES) WASTEWATER TREATMENT SYSTEMS ARE APPROVED BY NHDES AS ITA (#2010—07—01, ISSUED JULY 30, 2010) IN ACCORDANCE WITH PART ENV—WQ 1000. THE SYSTEM IS DESIGNED IN ACCORDANCE WITH THE ADVANCED ENVIRO—SEPTIC LEACHING SYSTEMS DESIGN AND INSTALLATION MANUAL AND THE ADVANCED ENVIRO—SEPTIC WASTEWATER TREATMENT SYSTEMS DESIGN AND INSTALLATION MANUAL NEW HAMPSHIRE STATE ATTACHMENT.
- NO SNOW SHALL BE STORED OR PLACED ON LEACHFIELDS OTHER THAN THAT WHICH FALLS NATURALLY.
- 8) COUNTY SOIL: 35A CHAMPLAIN LOAMY FINE SAND 0 TO 3 % SLOPES (NRCS WEB SOIL SURVEY)

# **OPERATING REQUIREMENTS**

- SYSTEM IS NOT DESIGNED TO HANDLE GARBAGE DISPOSALS OR WATER TREATMENT BACKWASH, OR JETTED TUBS.
- 2) TO PREVENT OBSTRUCTION OF THE DISTRIBUTION LINES AND LEACH FIELD, GREASE AND BULKY WASTES SHALL NOT BE FLUSHED OR INTRODUCED INTO THE SEPTIC SYSTEM.
- TOXIC AND HAZARDOUS MATERIALS SHALL NOT BE INTRODUCED INTO THE SEPTIC SYSTEM.
- 4) DO NOT ALLOW VEHICULAR TRAFFIC OVER ANY COMPONENT OF THE SYSTEM UNLESS THAT STRUCTURE IS DESIGNED TO WITHSTAND HS-20 WHEEL LOADING.
- SEAL ALL CONSTRUCTION JOINTS WITH DOUBLE LAYER OF 1" DIAMETER BUTYL RUBBER OR EQUIVALENT.
- 6) ALL PIPE CONNECTORS AT STRUCTURES SHALL BE WATERTIGHT FLEXIBLE BOOTS FREE OF GROUT, ALL HARDWARE TO BE STAINLESS STEEL.
- 7) PROVIDE FULL VENTING OF ALL COMPONENTS TO CODE AND PER PRESBY
- 8) NO FOUNDATION DRAINS ARE PROPOSED WITHIN 25 FEET OF LEACHFIELD.

# TEST PITS

DATE: MAY 3, 2021

PERFORMED BY: A&M — MICHAEL MALYNOWSKI, NHDES SEPTIC DESIGNER

TEST PIT #1

C=12"

LOVE 3/6 LOAMY SAND

0-12" 10YR 3/6 LOAMY SAND 12-28" 10YR 5/6 LOAMY FINE SAND 28-84" 10YR 6/6 LOAMY FINE SAND

NO OBSERVED REDOX

NO OBSERVED WATER

TEST PIT #2

0-12"

10YR 3/6 LOAMY SAND

12-22"

10YR 5/6 LOAMY FINE SAND

10YR 6/6 LOAMY FINE SAND

22-84" 10YR 6/6 LOAMY FINE SAND NO OBSERVED WATER NO OBSERVED REDOX

TEST PIT #3 EXISTING GROUND ELEVATION = 374.0

0-12" 10YR 3/6 LOAMY SAND

12-23" 10YR 5/6 LOAMY FINE SAND

23-84" 10YR 6/6 LOAMY FINE SAND

NO OBSERVED WATER

NO OBSERVED REDOX

USED

PIT

TEST PIT #4 EXISTING GROUND ELEVATION = 374.0

0-8" 10YR 3/6 LOAMY FINE SAND

8-22" 10YR 5/6 LOAMY FINE SAND

22-38" 10YR 6/6 LOAMY FINE SAND

38-79" 2.5Y 7/1 LOAMY FINE SAND

NO OBSERVED WATER

NO OBSERVED REDOX

TEST PIT #5 EXISTING GROUND ELEVATION = 374.0

0-8" 10YR 3/6 LOAMY FINE SAND

8-26" 10YR 4/6 LOAMY FINE SAND

26-72" 2.5Y 6/4 LOAMY FINE SAND

NO OBSERVED WATER


REDOX OBSERVED @44"


TEST PIT #6


0-8"
10YR 3/4 LOAMY FINE SAND
8-26"
10YR 4/6 LOAMY FINE SAND
26-84"
2.5Y 6/4 LOAMY FINE SAND
NO OBSERVED WATER
REDOX OBSERVED @36"


# **LEACH FIELD NOTES**


- 1) MINIMUM OF 6" OF MEDIUM TO COARSE SAND WITH LESS THAN 2% PASSING A # 200 SIEVE REQUIRED AROUND CIRCUMFERENCE OF ENVIRO—SEPTIC PIPES. (SEE DESIGN AND INSTALLATION MANUAL FOR COMPLETE SAND AND FILL SPECIFICATIONS.)
- 1) ALL SYSTEMS SAND SHALL BE ASTM C33 FINE AGGREGATE CONCRETE SAND, SILICA BASED (NOT LIMESTONE BASED), CLEAN, UNCONTAMINATED. ALL MATERIAL SHALL BE REVIEWED AND APPROVED BY PRESBY ENVIRONMENTAL AND INCLUDE LAB AND FIELD TESTING CERTIFICATES PRIOR AND DURING CONSTRUCTION, RESPECTIVELY.
- 2) ALL VENTING SYSTEMS SHALL BE INDEPENDENT AND SEPARATE WITH NO INTERCONNECTS
- 3) INSPECTION PROVISIONS SHALL BE ACCOMMODATED FOR TOWN AND STATE OFFICIALS AS REQUIRED IN LOCAL AND STATE REGULATIONS.
- 4) ENVIRO-SEPTIC PIPE TO BE LAID LEVEL.

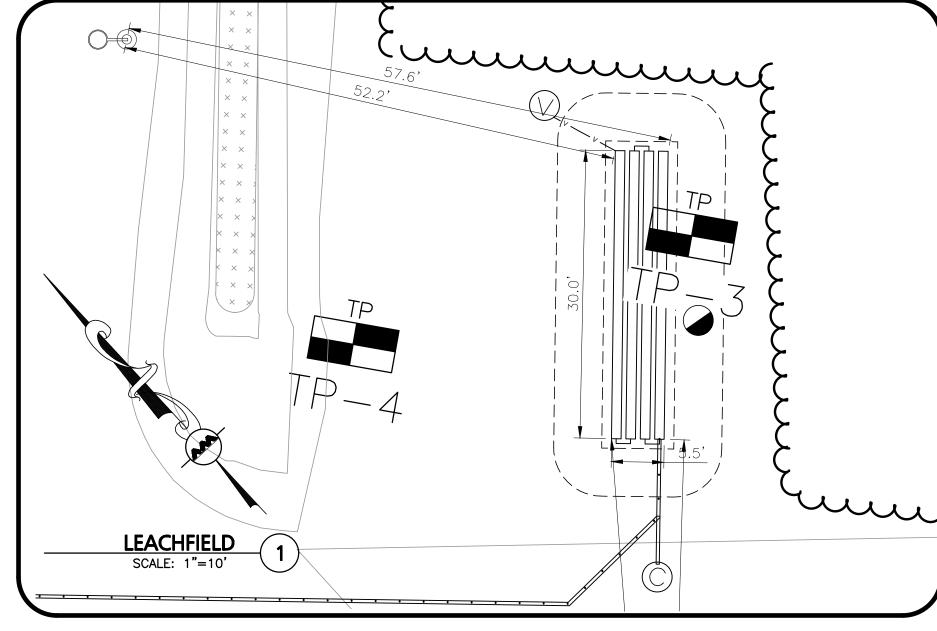


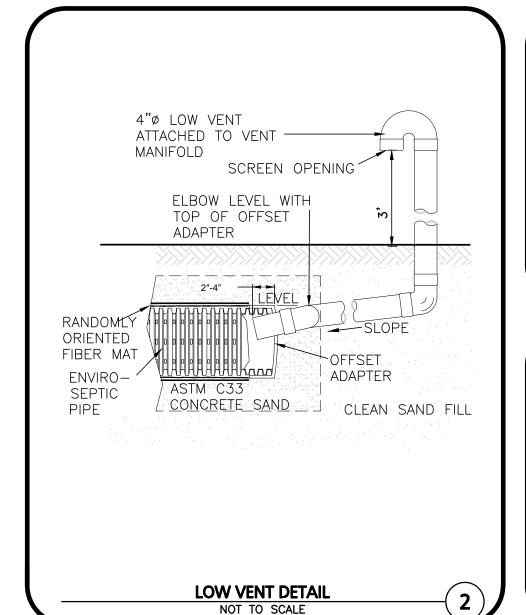

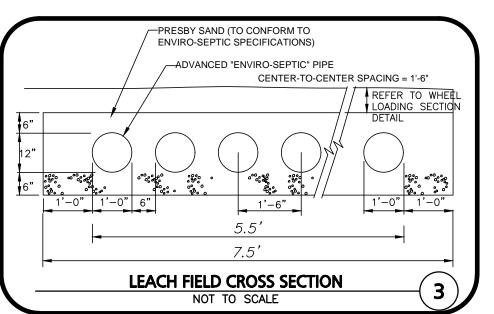

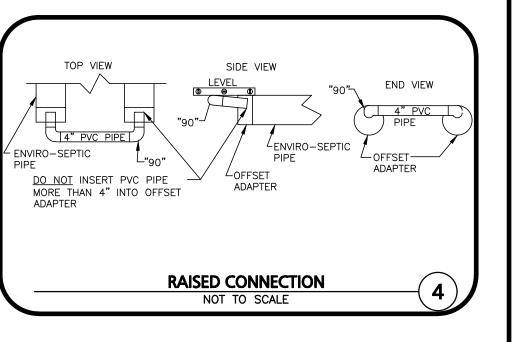

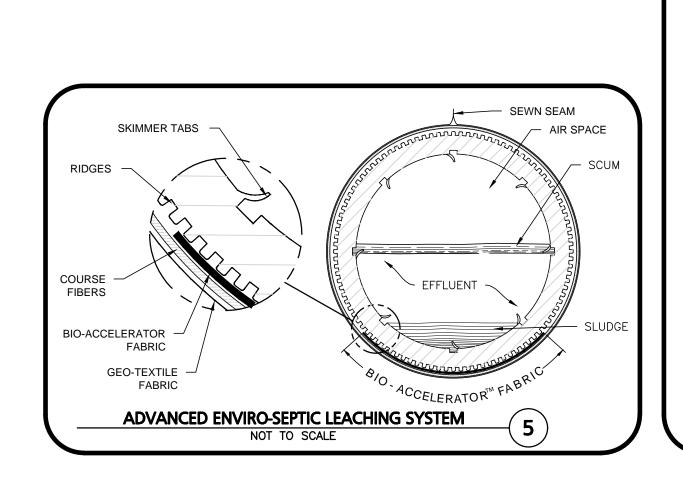

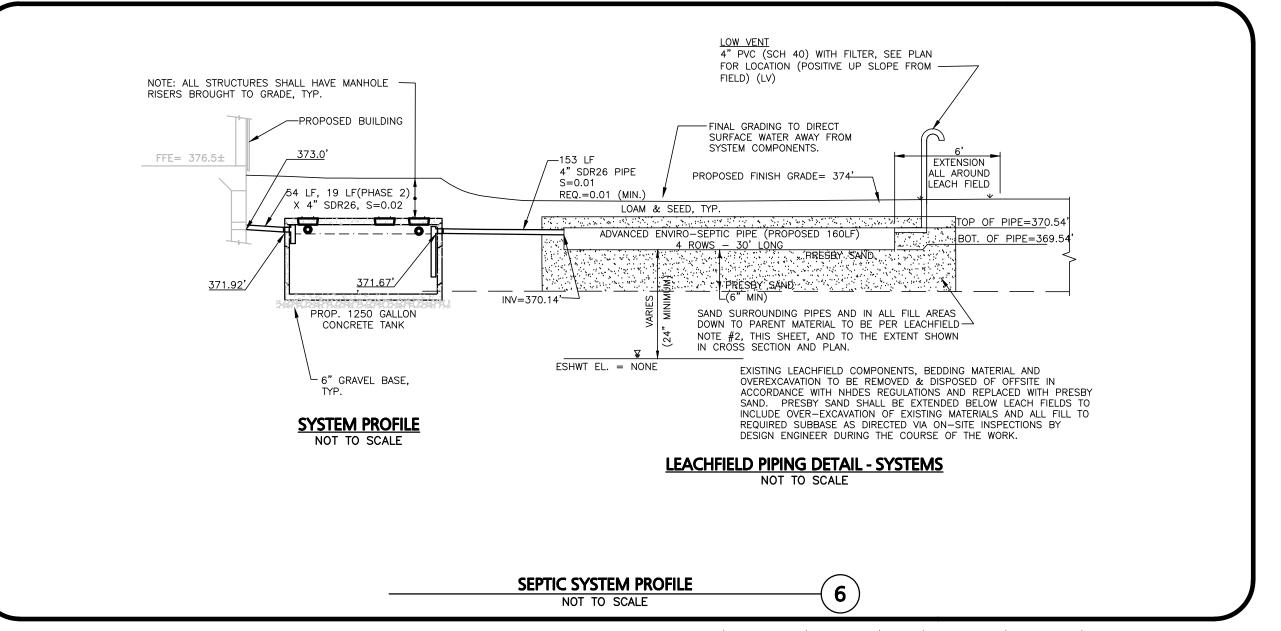

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NHDES DESIGNER OF SUBSURFACE SYSTEM FOR ALLEN & MAJOR ASSOCIATES, INC.

1 5-17-2021 ISSUED FOR REVIEW
REV DATE DESCRIPTION

APPLICANT\OWNER:

STATION MEADOW, LLC 4 DUNLAP ROAD BURLINGTON, MA 01803

PROJECT:

TAX MAP 251, LOT 18

HALL ROAD

CANTERBURY, NH

PROJECT NO. 2915-01 DATE: 5/17/2020

SCALE: AS SHOWN DWG. NAME: C2915-01



ASSOCIATES, INC.

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400 HARVEY ROAD MANCHESTER, NH 03103 TEL: (603) 627-5500 FAX: (603) 627-5501

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